

Project: Klamath Community College Childcare Learning Center (2331.00)

Date: September 17, 2025

To: Interested Bidders

Prepared by: Karen Williams, AIA

This Addendum modifies the Project Manual, Specifications, and Drawings as follows:

1. General Information

1.1. **Last Addendum –** This is the last addendum.

2. Changes to the Project Manual

- 2.1. Section Contractors Insurance Exhibit A A101 2017
 - 2.1.1. Added information

3. Changes to the Drawings

ARCHITECTURE:

- 3.1. Sheet A016 UTILITY COURT GATE DETAILS
 - 3.1.1. <u>REVISED drawing and ADDED keynotes to detail 1 UTILITY ROLLING</u>
 GATE JAMB N
 - 3.1.2. REVISED drawing and ADDED keynotes to detail 2 UTILITY ROLLING GATE JAMB S
 - 3.1.3. REVISED drawing and ADDED keynotes to detail 1 UTILITY PEDESTRIAN GATE JAMB

3.2. Sheet A115 - CLERESTORY PLAN - SECTOR A

3.2.1. - Revised mezzanine to incorporate the access panel and integrated stair and ladder.

3.3. Sheet A116 - CLERESTORY PLAN - SECTOR B

3.3.1. Revised mezzanine to incorporate the access panel and integrated stair and ladder.

3.4. Sheet A121 - REFLECTED CEILING PLAN - SECTOR A

3.4.1. - Added access hatch with integrated ladder.

3.5. Sheet A122 - REFLECTED CEILING PLAN - SECTOR B

3.5.1. - Added access hatch with integrated ladder.

3.6. Sheet A200 – EXTERIOR MATERIAL AND FINISH LEGEND

3.6.1. - Revised fascia flashing 2 to be a metal panel profile from bent metal

KCC CLC (2331) September 17, 2025 Addendum #7

3.7. Sheet A310 – WALL SECTION

3.7.1. - Revised detail callouts to reference correct condition detail

3.8. Sheet A335 – CANOPY DETAILS

- 3.8.1. Added new detail for canopy beam at wall
- 3.8.2. Revised canopy edge detail for finish materials and height

3.9. Sheet A630 - TYP. OPENING DETAILS

3.9.1. NEW SHEET

3.10. Sheet A635 – DOOR DETAILS

3.10.1. NEW SHEET

3.11. Sheet A638 – STOREFRONT DETAILS

3.11.1. NEW SHEET

3.12. Sheet A650 - INTERIOR WINDOW DETAILS

3.12.1. NEW SHEET

3.13. Sheet A653 – INTERIOR DOOR DETAILS

3.13.1. NEW SHEET

STRUCTURE:

3.14. Sheet S213 & S214

- 3.14.1. Revised mezzanine floor framing to have floor joists stop short of stud wall and be supported by GLB.
- 3.14.2. Added 2x blocking to panel edges of mezzanine floor sheathing, Keynote 1.
- 3.14.3. Revised keynote 3 to be GLB.
- 3.14.4. Revised keynote 7 GLB size
- 3.14.5. Revised size of ceiling attic access panel size for keynote 8.

3.15. Sheet S501

3.15.1. Revised Detail 6/S501 to reflect change in mezzanine framing stopping short of stud wall.

Substitution Approvals

3.16. None at this time

4. Attachments

- 4.1. KCC CLC ADD 007 Coversheet and Project Manual.pdf
- 4.2. KCC ELC ADD 007 Drawings.pdf

5. Bidder Questions:

5.1. **Question:** There are 3 mixing valves shown at the water heaters, but there are no models listed in the fixture schedule or specifications. Manufacturers are listed

in specifications, however. Should we find appropriate valves for the applications and submit on those from the listed manufacturers or will models be provided by the engineering team?

- 5.1.1. **Response:** See revised schedules provided in addendum 6.
- 5.2. **Question:** In addendum 4, circuit setters and balancing valves were added to the recirculation system, can the engineering team please provide a model and manufacturer that would meet their requirements. The circuit setters are only listed in details 1/501 and 2/501. No further information about circuit setters is shown in the fixture schedule or specifications. Balancing valves do show approved manufactures in the specifications and flow rates in the details, but no approved model.
 - 5.2.1. **Response:** Owner/General Contractor to choose specific model number to match installation preferences/requirements.

End	of	Addenda
-----	----	---------

DRAFT AIA Document A101 - 2017

Exhibit A

Insurance and Bonds

This Insurance and Bonds Exhibit is part of the Agreement, between the Owner and the Contractor, dated the way day of way in the year way (In words, indicate day, month and year.)

for the following **PROJECT**:

(Name and location or address)

Klamath Community College Childcare Learning Center South 6th Street Klamath Falls, OR 97603

THE OWNER:

(Name, legal status and address)

Klamath Community College 7390 South 6th Street Klamath Falls, OR 97603

THE CONTRACTOR:

(Name, legal status and address)

«» «

TABLE OF ARTICLES

- A.1 GENERAL
- A.2 OWNER'S INSURANCE
- A.3 CONTRACTOR'S INSURANCE AND BONDS
- A.4 SPECIAL TERMS AND CONDITIONS

ARTICLE A.1 GENERAL

The Owner and Contractor shall purchase and maintain insurance, and provide bonds, as set forth in this Exhibit. As used in this Exhibit, the term General Conditions refers to AIA Document A201TM—2017, General Conditions of the Contract for Construction.

ARTICLE A.2 OWNER'S INSURANCE § A.2.1 General

Prior to commencement of the Work, the Owner shall secure the insurance, and provide evidence of the coverage, required under this Article A.2 and, upon the Contractor's request, provide a copy of the property insurance policy or policies required by Section A.2.3. The copy of the policy or policies provided shall contain all applicable conditions, definitions, exclusions, and endorsements.

ADDITIONS AND DELETIONS:

The author of this document has added information needed for its completion. The author may also have revised the text of the original AIA standard form. An Additions and Deletions Report that notes added information as well as revisions to the standard form text is available from the author and should be reviewed.

This document has important legal consequences. Consultation with an attorney is encouraged with respect to its completion or modification.

This document is intended to be used in conjunction with AIA Document A201®-2017, General Conditions of the Contract for Construction. Article 11 of A201®-2017 contains additional insurance provisions.



ELECTRONIC COPYING of any portion of this AIA® Document to another electronic file is prohibited and constitutes a violation of copyright laws as set forth in the footer of this document.

1

AIA Document A101 - 2017 Exhibit A. Copyright © 2017. All rights reserved. "The American Institute of Architects," "AIA," the AIA Logo, and "AIA Contract Documents" are trademarks of The American Institute of Architects. This draft was produced at 13:52:32 ET on 08/29/2025 under Order No.4104245767 which expires on 10/01/2025, is not for resale, is licensed for one-time use only, and may only be used in accordance with the AIA Contract Documents® Terms of Service. To report copyright violations, e-mail docinfo@aiacontracts.com.

Notes: (1261527373)

§ A.2.2 Liability Insurance

The Owner shall be responsible for purchasing and maintaining the Owner's usual general liability insurance.

§ A.2.3 Required Property Insurance

§ A.2.3.1 Unless this obligation is placed on the Contractor pursuant to Section A.3.3.2.1, the Owner shall purchase and maintain, from an insurance company or insurance companies lawfully authorized to issue insurance in the jurisdiction where the Project is located, property insurance written on a builder's risk "all-risks" completed value or equivalent policy form and sufficient to cover the total value of the entire Project on a replacement cost basis. The Owner's property insurance coverage shall be no less than the amount of the initial Contract Sum, plus the value of subsequent Modifications and labor performed and materials or equipment supplied by others. The property insurance shall be maintained until Substantial Completion and thereafter as provided in Section A.2.3.1.3, unless otherwise provided in the Contract Documents or otherwise agreed in writing by the parties to this Agreement. This insurance shall include the interests of the Owner, Contractor, Subcontractors, and Sub-subcontractors in the Project as insureds. This insurance shall include the interests of mortgagees as loss payees.

§ A.2.3.1.1 Causes of Loss. The insurance required by this Section A.2.3.1 shall provide coverage for direct physical loss or damage, and shall not exclude the risks of fire, explosion, theft, vandalism, malicious mischief, collapse, earthquake, flood, or windstorm. The insurance shall also provide coverage for ensuing loss or resulting damage from error, omission, or deficiency in construction methods, design, specifications, workmanship, or materials. Sublimits, if any, are as follows:

(Indicate below the cause of loss and any applicable sub-limit.)

Causes of Loss	Sub-Limit		

§ A.2.3.1.2 Specific Required Coverages. The insurance required by this Section A.2.3.1 shall provide coverage for loss or damage to falsework and other temporary structures, and to building systems from testing and startup. The insurance shall also cover debris removal, including demolition occasioned by enforcement of any applicable legal requirements, and reasonable compensation for the Architect's and Contractor's services and expenses required as a result of such insured loss, including claim preparation expenses. Sub-limits, if any, are as follows: (Indicate below type of coverage and any applicable sub-limit for specific required coverages.)

Coverage	Sub-Limit		٧/	

§ A.2.3.1.3 Unless the parties agree otherwise, upon Substantial Completion, the Owner shall continue the insurance required by Section A.2.3.1 or, if necessary, replace the insurance policy required under Section A.2.3.1 with property insurance written for the total value of the Project that shall remain in effect until expiration of the period for correction of the Work set forth in Section 12.2.2 of the General Conditions.

§ A.2.3.1.4 Deductibles and Self-Insured Retentions. If the insurance required by this Section A.2.3 is subject to deductibles or self-insured retentions, the Owner shall be responsible for all loss not covered because of such deductibles or retentions.

§ A.2.3.2 Occupancy or Use Prior to Substantial Completion. The Owner's occupancy or use of any completed or partially completed portion of the Work prior to Substantial Completion shall not commence until the insurance company or companies providing the insurance under Section A.2.3.1 have consented in writing to the continuance of coverage. The Owner and the Contractor shall take no action with respect to partial occupancy or use that would cause cancellation, lapse, or reduction of insurance, unless they agree otherwise in writing.

§ A.2.3.3 Insurance for Existing Structures

If the Work involves remodeling an existing structure or constructing an addition to an existing structure, the Owner shall purchase and maintain, until the expiration of the period for correction of Work as set forth in Section 12.2.2 of the General Conditions, "all-risks" property insurance, on a replacement cost basis, protecting the existing structure against direct physical loss or damage from the causes of loss identified in Section A.2.3.1, notwithstanding the undertaking of the Work. The Owner shall be responsible for all co-insurance penalties.

§ A.2.4 Optional Extended Property Insurance. The Owner shall purchase and maintain the insurance selected and described below. (Select the types of insurance the Owner is required to purchase and maintain by placing an X in the box(es) next to the description(s) of selected insurance. For each type of insurance selected, indicate applicable limits of coverage or other conditions in the fill point below the selected item.)

ner cona	mons in the full point selection the selection than the selection than the selection than the selection than the selection that the selection than the selection that the selection than the selection that the selection than the selection that the selection than the selection that the selection that
[« »]	§ A.2.4.1 Loss of Use, Business Interruption, and Delay in Completion Insurance, to reimburse the Owner for loss of use of the Owner's property, or the inability to conduct normal operations due to a covered cause of loss.
	»
[« X »]	§ A.2.4.2 Ordinance or Law Insurance, for the reasonable and necessary costs to satisfy the minimum requirements of the enforcement of any law or ordinance regulating the demolition, construction, repair, replacement or use of the Project.
	« 50,000 »
[«»]	§ A.2.4.3 Expediting Cost Insurance, for the reasonable and necessary costs for the temporary repair of damage to insured property, and to expedite the permanent repair or replacement of the damaged property.
	«»
[« »]	§ A.2.4.4 Extra Expense Insurance, to provide reimbursement of the reasonable and necessary excess costs incurred during the period of restoration or repair of the damaged property that are over and above the total costs that would normally have been incurred during the same period of time had no loss or damage occurred.
	«»
[«»]	§ A.2.4.5 Civil Authority Insurance, for losses or costs arising from an order of a civil authority prohibiting access to the Project, provided such order is the direct result of physical damage covered under the required property insurance.
	« »
[« »]	§ A.2.4.6 Ingress/Egress Insurance, for loss due to the necessary interruption of the insured's business due to physical prevention of ingress to, or egress from, the Project as a direct result of physical damage.
	« »
[«X »]	§ A.2.4.7 Soft Costs Insurance, to reimburse the Owner for costs due to the delay of completion of the Work, arising out of physical loss or damage covered by the required property insurance: including construction loan fees; leasing and marketing expenses; additional fees, including those of architects engineers, consultants, attorneys and accountants, needed for the completion of the construction, repairs, or reconstruction; and carrying costs such as property taxes, building permits, additional interest on loans, realty taxes, and insurance premiums over and above normal expenses.

To Be Determined

§ A.2.5 Other Optional Insurance.

The Owner shall purchase and maintain the insurance selected below.

(Select the types of insurance the Owner is required to purchase and maintain by placing an X in the box(es) next to the description(s) of selected insurance.)

[«»]	including costs of investigating a poter	oss to the Owner due to data security and privacy breach, atial or actual breach of confidential or private information. or other conditions in the fill point below.)
	« »	
[« »]	§ A.2.5.2 Other Insurance (List below any other insurance covera	age to be provided by the Owner and any applicable limits.)
Co	verage	Limits

ARTICLE A.3 CONTRACTOR'S INSURANCE AND BONDS

§ A.3.1 General

§ A.3.1.1 Certificates of Insurance. The Contractor shall provide certificates of insurance acceptable to the Owner evidencing compliance with the requirements in this Article A.3 at the following times: (1) prior to commencement of the Work; (2) upon renewal or replacement of each required policy of insurance; and (3) upon the Owner's written request. An additional certificate evidencing continuation of commercial liability coverage, including coverage for completed operations, shall be submitted with the final Application for Payment and thereafter upon renewal or replacement of such coverage until the expiration of the periods required by Section A.3.2.1 and Section A.3.3.1. The certificates will show the Owner as an additional insured on the Contractor's Commercial General Liability and excess or umbrella liability policy or policies.

§ A.3.1.2 Deductibles and Self-Insured Retentions. The Contractor shall disclose to the Owner any deductible or self-insured retentions applicable to any insurance required to be provided by the Contractor.

§ A.3.1.3 Additional Insured Obligations. To the fullest extent permitted by law, the Contractor shall cause the commercial general liability coverage to include (1) the Owner, the Architect, and the Architect's consultants as additional insureds for claims caused in whole or in part by the Contractor's negligent acts or omissions during the Contractor's operations; and (2) the Owner as an additional insured for claims caused in whole or in part by the Contractor's negligent acts or omissions for which loss occurs during completed operations. The additional insured coverage shall be primary and non-contributory to any of the Owner's general liability insurance policies and shall apply to both ongoing and completed operations. To the extent commercially available, the additional insured coverage shall be no less than that provided by Insurance Services Office, Inc. (ISO) forms CG 20 10 07 04, CG 20 37 07 04, and, with respect to the Architect and the Architect's consultants, CG 20 32 07 04.

§ A.3.2 Contractor's Required Insurance Coverage

§ A.3.2.1 The Contractor shall purchase and maintain the following types and limits of insurance from an insurance company or insurance companies lawfully authorized to issue insurance in the jurisdiction where the Project is located. The Contractor shall maintain the required insurance until the expiration of the period for correction of Work as set forth in Section 12.2.2 of the General Conditions, unless a different duration is stated below: (If the Contractor is required to maintain insurance for a duration other than the expiration of the period for correction of Work, state the duration.)

« »

§ A.3.2.2 Commercial General Liability

§ A.3.2.2.1 Commercial General Liability insurance for the Project written on an occurrence form with policy limits of not less than «one million dollars » (\$ «1,000,000 ») each occurrence, «two million dollars » (\$ «2,000,000») general aggregate, and «two million dollars» (\$ «2,000,000») aggregate for products-completed operations hazard, providing coverage for claims including

.1 damages because of bodily injury, sickness or disease, including occupational sickness or disease, and death of any person;

AIA Document A101 - 2017 Exhibit A. Copyright © 2017. All rights reserved. "The American Institute of Architects," "AIA," the AIA Logo, and "AIA Contract Documents" are trademarks of The American Institute of Architects. This draft was produced at 13:52:32 ET on 08/29/2025 under Order No.4104245767 which expires on 10/01/2025, is not for resale, is licensed for one-time use only, and may only be used in accordance with the AIA Contract Documents® Terms of Service. To report copyright violations, e-mail docinfo@aiacontracts.com.

- .2 personal injury and advertising injury;
- .3 damages because of physical damage to or destruction of tangible property, including the loss of use of such property;
- .4 bodily injury or property damage arising out of completed operations; and
- .5 the Contractor's indemnity obligations under Section 3.18 of the General Conditions.

§ A.3.2.2.2 The Contractor's Commercial General Liability policy under this Section A.3.2.2 shall not contain an exclusion or restriction of coverage for the following:

- .1 Claims by one insured against another insured, if the exclusion or restriction is based solely on the fact that the claimant is an insured, and there would otherwise be coverage for the claim.
- .2 Claims for property damage to the Contractor's Work arising out of the products-completed operations hazard where the damaged Work or the Work out of which the damage arises was performed by a Subcontractor.
- .3 Claims for bodily injury other than to employees of the insured.
- .4 Claims for indemnity under Section 3.18 of the General Conditions arising out of injury to employees of the insured.
- .5 Claims or loss excluded under a prior work endorsement or other similar exclusionary language.
- .6 Claims or loss due to physical damage under a prior injury endorsement or similar exclusionary language.
- .7 Claims related to residential, multi-family, or other habitational projects, if the Work is to be performed on such a project.
- .8 Claims related to roofing, if the Work involves roofing.
- .9 Claims related to exterior insulation finish systems (EIFS), synthetic stucco or similar exterior coatings or surfaces, if the Work involves such coatings or surfaces.
- .10 Claims related to earth subsidence or movement, where the Work involves such hazards.
- .11 Claims related to explosion, collapse and underground hazards, where the Work involves such hazards.
- § A.3.2.3 Automobile Liability covering vehicles owned, and non-owned vehicles used, by the Contractor, with policy limits of not less than « one million dollars » (\$ «1,000,000») per accident, for bodily injury, death of any person, and property damage arising out of the ownership, maintenance and use of those motor vehicles along with any other statutorily required automobile coverage.
- § A.3.2.4 The Contractor may achieve the required limits and coverage for Commercial General Liability and Automobile Liability through a combination of primary and excess or umbrella liability insurance, provided such primary and excess or umbrella insurance policies result in the same or greater coverage as the coverages required under Section A.3.2.2 and A.3.2.3, and in no event shall any excess or umbrella liability insurance provide narrower coverage than the primary policy. The excess policy shall not require the exhaustion of the underlying limits only through the actual payment by the underlying insurers.
- § A.3.2.5 Workers' Compensation at statutory limits.
- § A.3.2.6 Employers' Liability with policy limits not less than « five hundred thousand dollars » (\$ «500,000») each accident, «five hundred thousand dollars » (\$ «500,000») each employee, and «five hundred thousand dollars» (\$ «500,000») policy limit.
- § A.3.2.7 Jones Act, and the Longshore & Harbor Workers' Compensation Act, as required, if the Work involves hazards arising from work on or near navigable waterways, including vessels and docks
- § A.3.2.8 If the Contractor is required to furnish professional services as part of the Work, the Contractor shall procure Professional Liability insurance covering performance of the professional services, with policy limits of not less than «not applicable» (\$ «N/A») per claim and «not applicable» (\$ «N/A») in the aggregate.
- § A.3.2.9 If the Work involves the transport, dissemination, use, or release of pollutants, the Contractor shall procure Pollution Liability insurance, with policy limits of not less than «not applicable » (\$ «N/A») per claim and «not applicable » (\$ « N/A ») in the aggregate.

§ A.3.2.10 Coverage under Sections A.3.2.8 and A.3.2.9 may be procured through a Combined Professional Liability and Pollution Liability insurance policy, with combined policy limits of not less than «not applicable» (\$ «N/A») per claim and «not applicable» (\$ «N/A») in the aggregate.

§ A.3.2.11 Insurance for maritime liability risks associated with the operation of a vessel, if the Work requires such activities, with policy limits of not less than «not applicable» (\$ «N/A») per claim and «not applicable» (\$ «N/A») in the aggregate.

§ A.3.2.12 Insurance for the use or operation of manned or unmanned aircraft, if the Work requires such activities, with policy limits of not less than one million dollars (\$ 1,000,000) per claim and «two million dollars» (\$ «2,000,000») in the aggregate.

§ A.3.3 Contractor's Other Insurance Coverage

§ A.3.3.1 Insurance selected and described in this Section A.3.3 shall be purchased from an insurance company or insurance companies lawfully authorized to issue insurance in the jurisdiction where the Project is located. The Contractor shall maintain the required insurance until the expiration of the period for correction of Work as set forth in Section 12.2.2 of the General Conditions, unless a different duration is stated below:

(If the Contractor is required to maintain any of the types of insurance selected below for a duration other than the expiration of the period for correction of Work, state the duration.)

« »

§ A.3.2 The Contractor shall purchase and maintain the following types and limits of insurance in accordance with Section A.3.3.1.

(Select the types of insurance the Contractor is required to purchase and maintain by placing an X in the box(es) next to the description(s) of selected insurance. Where policy limits are provided, include the policy limit in the appropriate fill point.)

« »

- [« »] § A.3.3.2.2 Railroad Protective Liability Insurance, with policy limits of not less than « » (\$ « ») per claim and « » (\$ « ») in the aggregate, for Work within fifty (50) feet of railroad property.
- [« »] § A.3.3.2.3 Asbestos Abatement Liability Insurance, with policy limits of not less than « » (\$ « ») per claim and « » (\$ « ») in the aggregate, for liability arising from the encapsulation, removal, handling, storage, transportation, and disposal of asbestos-containing materials.
- [(»] § A.3.3.2.4 Insurance for physical damage to property while it is in storage and in transit to the construction site on an "all-risks" completed value form.


(1261527373)

[« »]	§ A.3.3.2.5 Property insurance on an "all-risks" completed value form, covering property owned by the Contractor and used on the Project, including scaffolding and other equipment.					
[« »]	§ A.3.3.2.6 Other Insurance (List below any other insuran limits.)	ce coverage to be provided	by the Contractor and any applicable			
Cov	erage	Limits				
The Contractor in the jurisdict	nance Bond and Payment Bond or shall provide surety bonds, f tion where the Project is locate and penal sum of bonds.)	rom a company or companio	es lawfully authorized to issue surety bonds			
Тур			Penal Sum (\$0.00)			
=	ment Bond		100% contract amount			
Per	formance Bond		100% contract amount			
ARTICLE A.4	ions identical to AIA Docume SPECIAL TERMS AND CONDIT and conditions that modify thi	IONS				
« »						

AIA Document A101 - 2017 Exhibit A. Copyright © 2017. All rights reserved. "The American Institute of Architects," "AMERICAN Institute of Architects," "AIA," the AIA Logo, and "AIA Contract Documents" are trademarks of The American Institute of Architects. This draft was produced at 13:52:32 ET on 08/29/2025 under Order No.4104245767 which expires on 10/01/2025, is not for resale, is licensed for one-time use only, and may only be used in accordance with the AIA Contract Documents® Terms of Service. To report copyright violations, e-mail docinfo@aiacontracts.com.


User Notes:

6 UTILITY PEDESTRIAN GATE
1/2" = 1'-0"

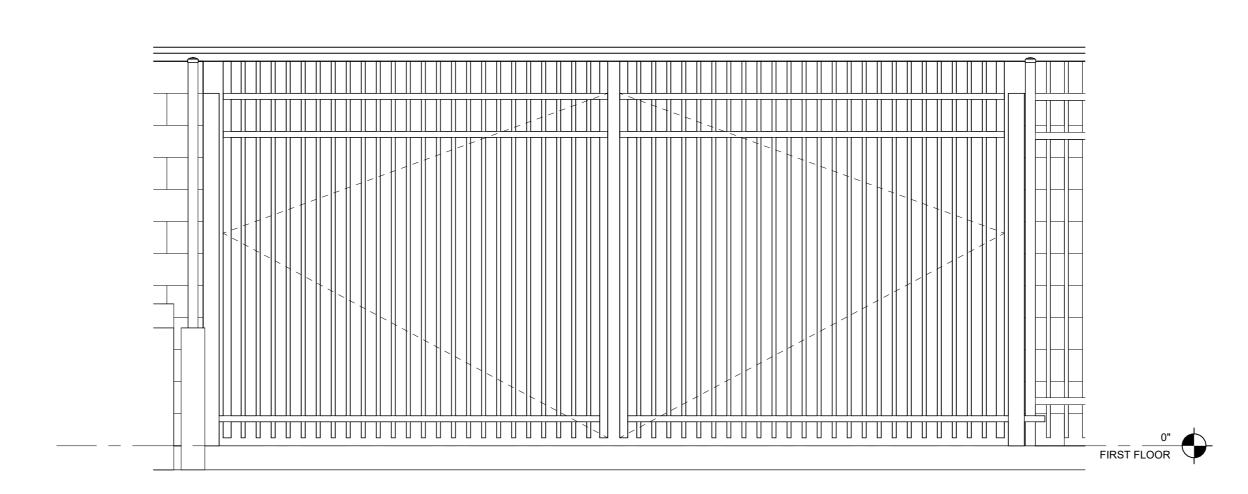


5 TRASH ENCLOSURE GATE


1/2" = 1'-0"

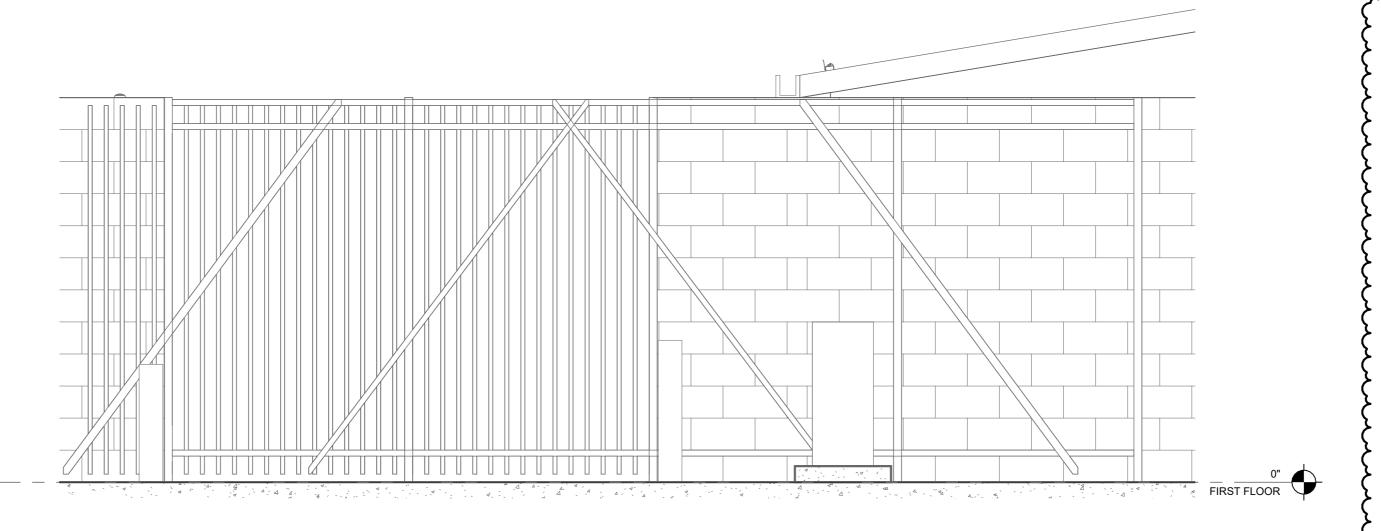


4 UTILITY ENLARGED ELEVATION - GATE - E

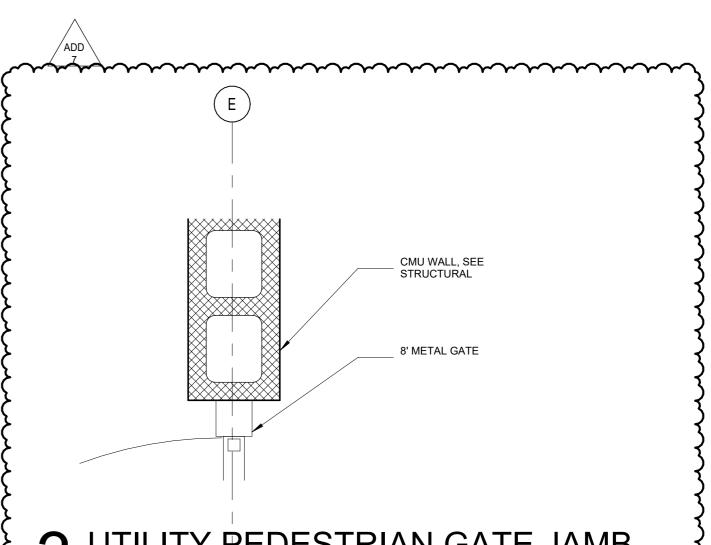

3 UTILITY PEDESTRIAN GATE JAMB

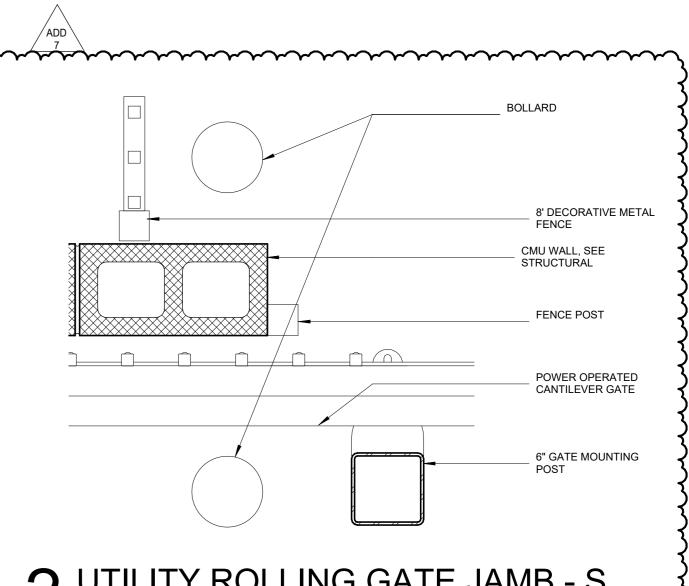

2 UTILITY ROLLING GATE JAMB - S

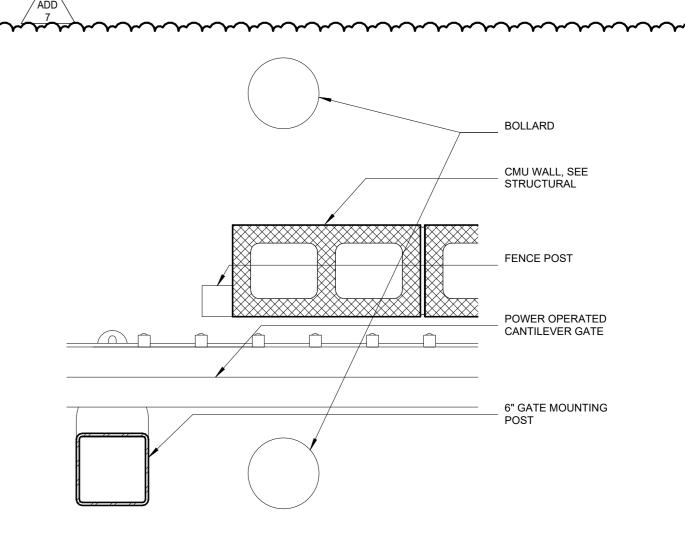

UTILITY ROLLING GATE JAMB - N



KLAMATH COMMUNITY COLLEGICHILDCARE LEARNING CENTER


SHEET TITLE: UTILITY **COURT GATE -DETAILS**

REVISIONS: 4 ADD 7

ISSUE DATE: 08/01/2025

4 ADD 7

ISSUE DATE: 08/01/2025

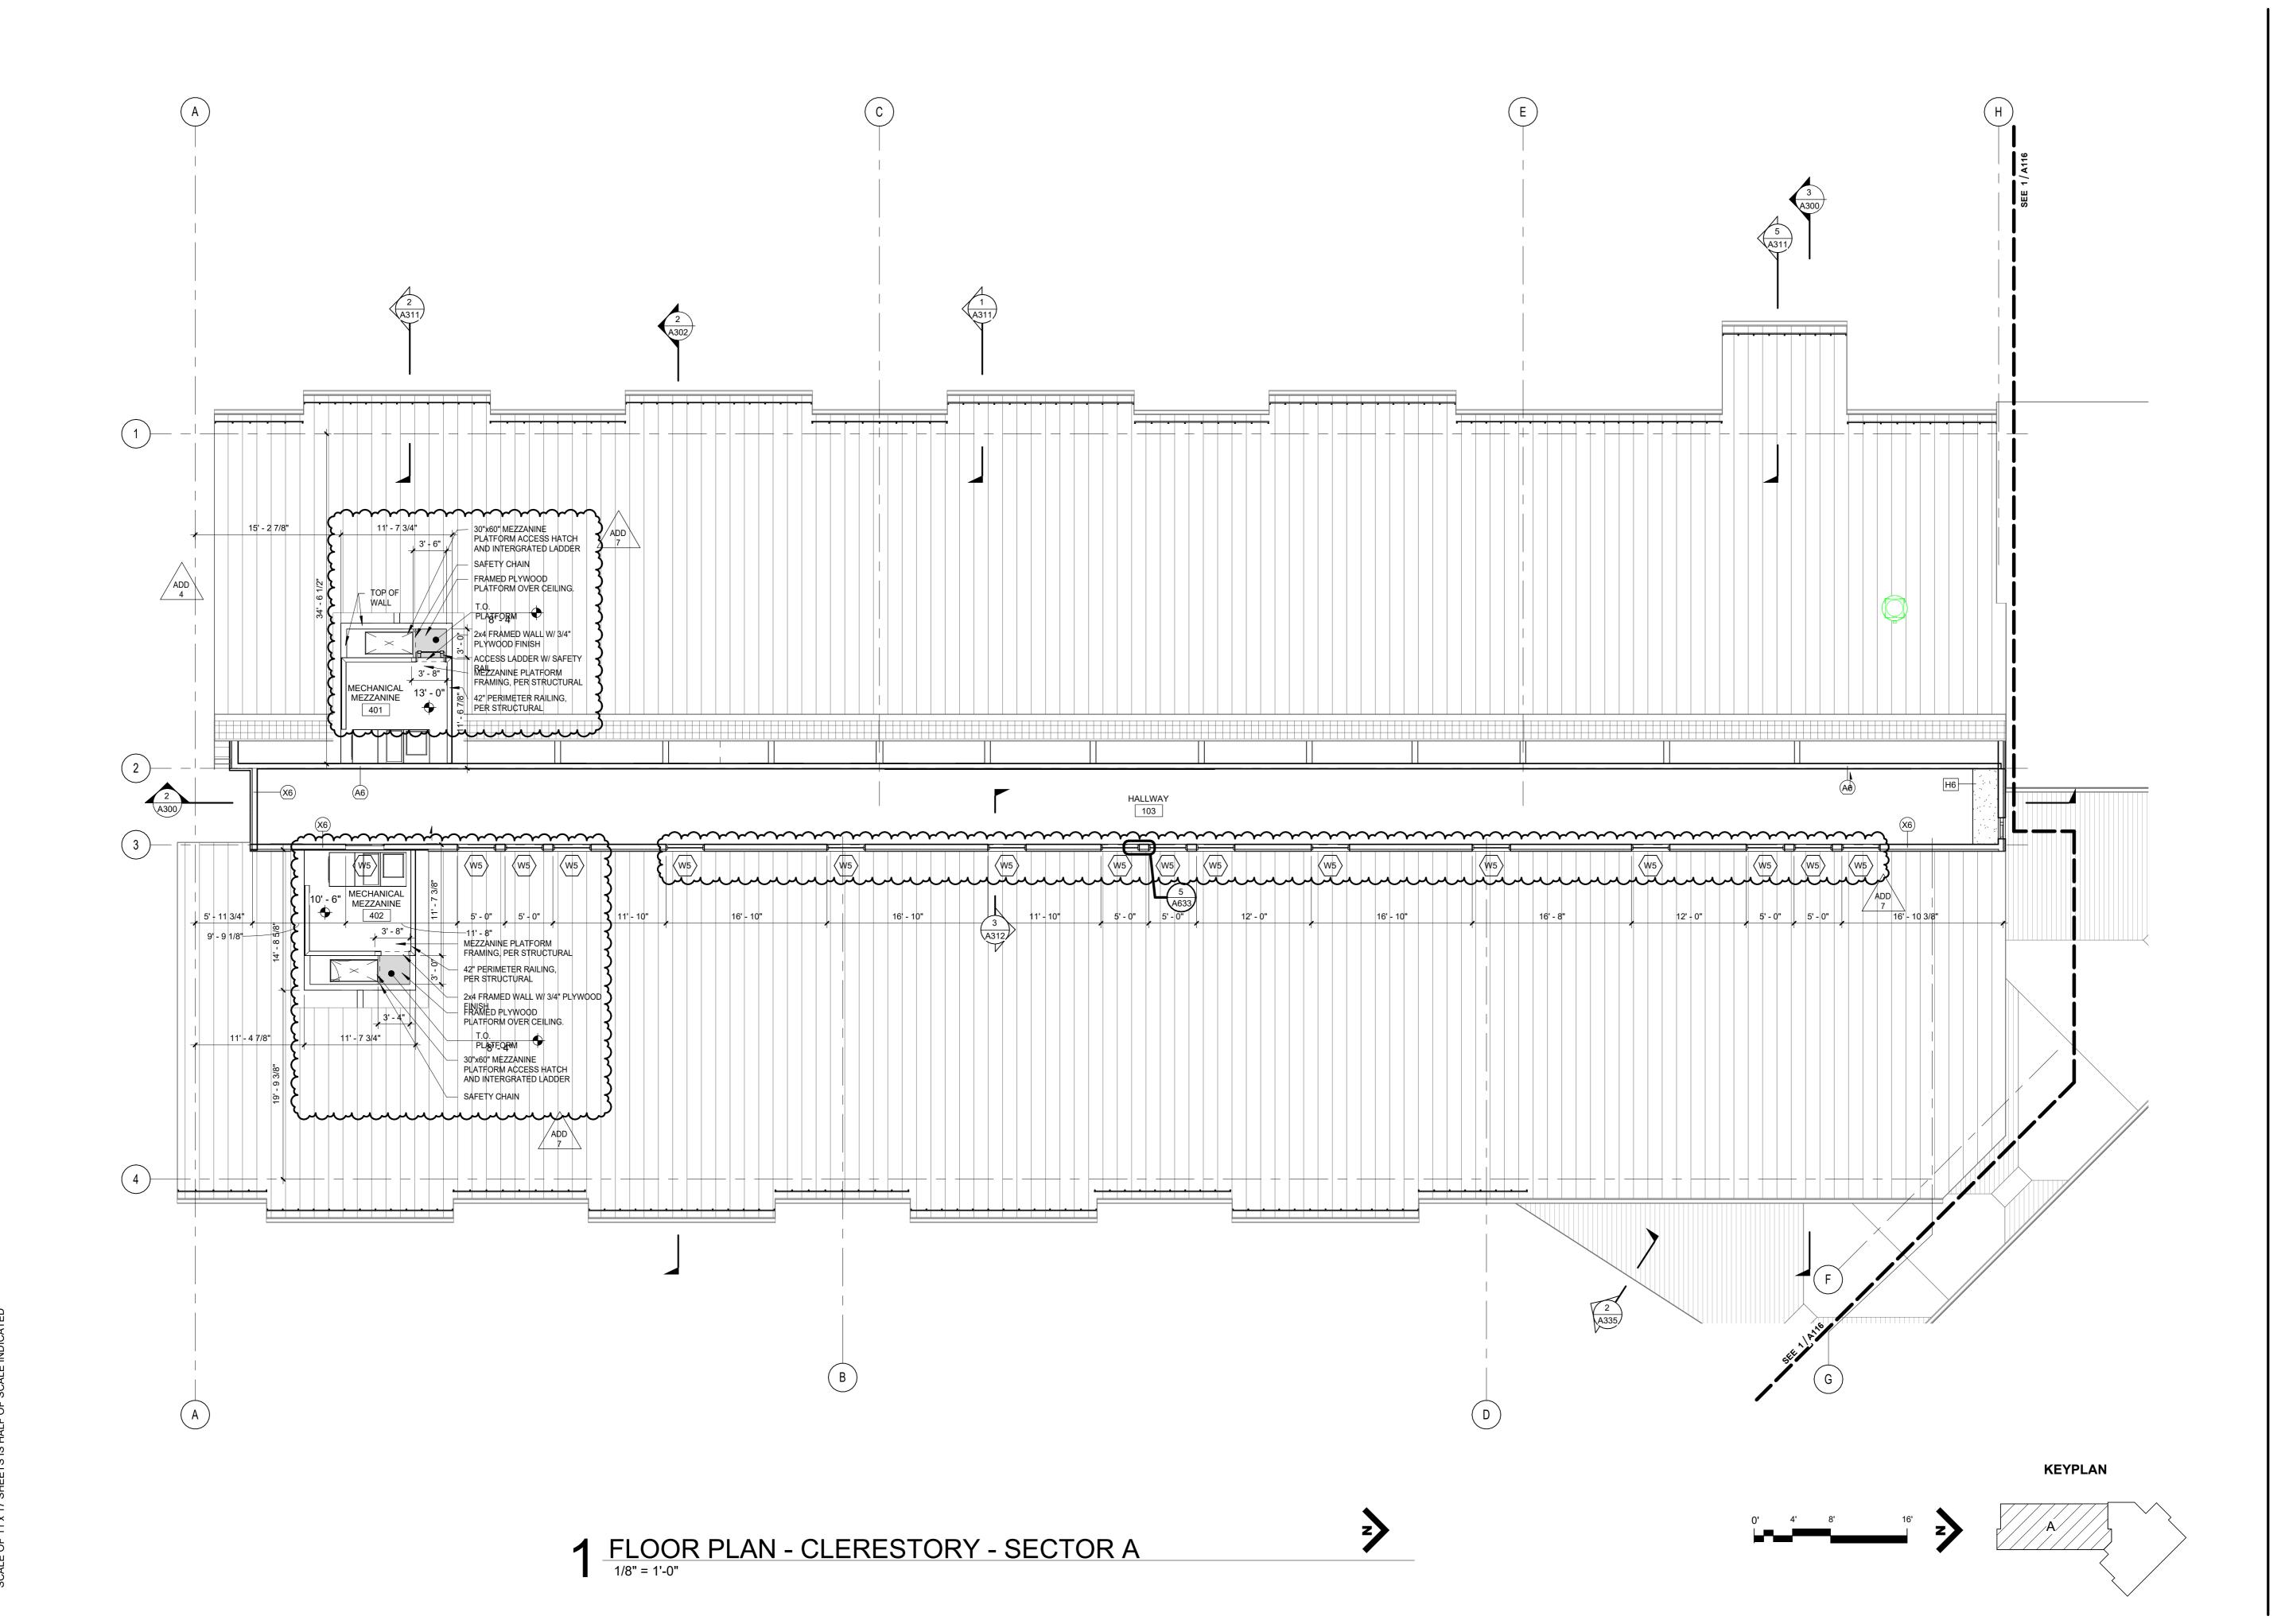

ARCHITECTURE



BID AND PERMIT SET
KLAMATH COMMUNITY COLLEGE
CHILDCARE LEARNING CENTER

SHEET TITLE:

CLERESTORY
PLAN SECTOR B

 RE۱	/ISIONS:	
#	DESCRP.	DATE
1 4	ADD 4 ADD 7	08.29.2025 09.17.2025

ISSUE DATE: 08/01/2025

ARCHITECTURE



KLAMATH COMMUNITY COLLEGE
CHILDCARE LEARNING CENTER
PROJECT #: 2331.00

- SECTOR A

SHEET TITLE:

REFLECTED

DESCRP. DATE

1 ADD 4 08.29.2025
2 ADD 5 09.04.2025
4 ADD 7 09.17.2025

ISSUE DATE: 08/01/2025

ARCHITECTURE •



MATH COMMUNITY COLLEGE
DCARE LEARNING CENTER

SHEET TITLE:

REFLECTED CEILING PLAN - SECTOR B

RE\	VISIONS:	
#	DESCRP.	DATE
1	ADD 4	08.29.2025
2	ADD 5	09.04.2025
4	ADD 7	09.17.2025

ISSUE DATE: 08/01/2025

EXTERIOR FINISH AND MATERIALS LEGEND

ABBV.	DESCRIPTION	ABBV.	DESCRIPTION		
MP-1	METAL PANEL (V)	MP-6	METAL PANEL (FLAT)	SV-1	STONE VENEER
	SPECIFICATION: 07 4213 METAL WALL PANELS TYPE: PRE-FINISHED METAL PANEL PROFILE: CASCADE 9 COLOR: ZINC GREY _ SRI-40 INSTALLATION: VERTICAL		SPECIFICATION: 07 4213 METAL WALL PANELS TYPE: PRE-FINISHED METAL PANEL PROFILE: DOUBLE V-GROOVE (LIFETIME SOFFIT) COLOR: MATTE BLACK _ SRI-23 INSTALLATION: VERTICAL		SPECIFICATION: 04 4313 STONE MASONRY VENEER TYPE: STONE VENEER STYLE: LEDGE COLOR: JUNEAU INSTALLATION: HORIZONTAL
MP-2	METAL PANEL (2X2)	MP-7	METAL PANEL (SOFFIT)	PC-1	PIER CAP
	SPECIFICATION: 07 4213 METAL WALL PANELS TYPE: PRE-FINISHED METAL PANEL PROFILE: C-5 COLOR: ZINC GREY _ SRI-40 INSTALLATION: PER ELEVATION		SPECIFICATION: 07 4293 METAL SOFFIT PANELS TYPE: PRE-FINISHED METAL SOFFIT PANEL PROFILE: VENTED (LIFETIME SOFFIT) COLOR: ZINC GREY _ SRI-40		SPECIFICATION: 04 4313 STONE MASONRY VENEER TYPE: FLAT PIER CAP STYLE: CHISELED EDGE COLOR: TAN
MP-3	METAL PANEL (3X3)	FF-1	FASCIA FLASHING (BLACK)	CMU-1	CMU
	SPECIFICATION: 07 4213 METAL WALL PANELS TYPE: PRE-FINISHED METAL PANEL PROFILE: CT-3 (C8-A) COLOR: ZINC GREY _ SRI-40 INSTALLATION: PER ELEVATION		SPECIFICATION: 07 6213 FABRICATED COPINGS TYPE: PRE-FINISHED METAL FLASHING PROFILE: BENT METAL COLOR: MATTE BLACK _ SRI-23		SPECIFICATION: 04 2223 ARCHITECTURAL CONCRETE UNIT MASONRY TYPE: CONCRETE MASONRY UNIT 8"x8"x16" STYLE: HORIZONTAL STACKED COLOR: LIGHT GREY
		\sim	~~~~~~~~~~~~~~~~~~~~~~~~~~~~~~~~~~~~~~		
MP-4	METAL PANEL (6X6)	FF-2	FASCIA FLASHING (GREY)	HPC-1	HIGH-PROFORMANCE COATING (RED)
	SPECIFICATION: 07 4213 METAL WALL PANELS TYPE: PRE-FINISHED METAL PANEL PROFILE: CT-4 (CR-A) COLOR: ZINC GREY _ SRI-40 INSTALLATION: VERTICAL	{ { 	SPECIFICATION: 07 4213 FABRICATED COPINGS TYPE: PRE-FINISHED METAL PANEL PROFILE: DOUBLE V-GROOVE (LIFETIME SOFFIT) COLOR: CHARCOAL GREY _ SRI-25 INSTALLATION: VERTICAL ADD 7		SPECIFICATION: 09 9600 HIGH - PROFORMANCE COATINGS COLOR: TO MATCH MP-5: TILE RED _ SRI-35
MP-5	METAL PANEL (RED)	SS-1	STANDING SEAM METAL ROOF (GREY)	HPC-2	HIGH-PROFORMANCE COATING (GREY)
	SPECIFICATION: 07 4213 METAL WALL PANELS TYPE: PRE-FINISHED METAL PANEL PROFILE: DOUBLE V-GROOVE (LIFETIME SOFFIT) COLOR: TILE RED _ SRI-35 INSTALLATION: VERTICAL		SPECIFICATION: 07 4113 METAL ROOF PANELS TYPE: STANDING SEAM METAL ROOF PANEL PROFILE: MS-200 COLOR: ZINC GREY _ SRI-40		SPECIFICATION: 09 9600 HIGH - PROFORMANCE COATINGS COLOR: TO MATCH MP-1: ZINC GREY _ SRI-40
				HPC-3	HIGH-PROFORMANCE COATING (BLACK)
					SPECIFICATION: 09 9600 HIGH - PROFORMANCE COATINGS COLOR: TO MATCH MP-6: MATTE BLACK _ SRI-23





KLAMATH COMMUNITY COLLEGE
CHILDCARE LEARNING CENTER
PROJECT #: 2331.00
KLAMATH COMMUNITY COLLEGE
7390 S. 6TH ST. KLAMATH FALLS, OR 97603

SHEET TITLE:


EXTERIOR MATERIAL AND FINISH LEGEND

REVISIONS:
DESCRP. DATE
4 ADD 7 09.17.2025

ISSUE DATE: 08/01/2025

N 200



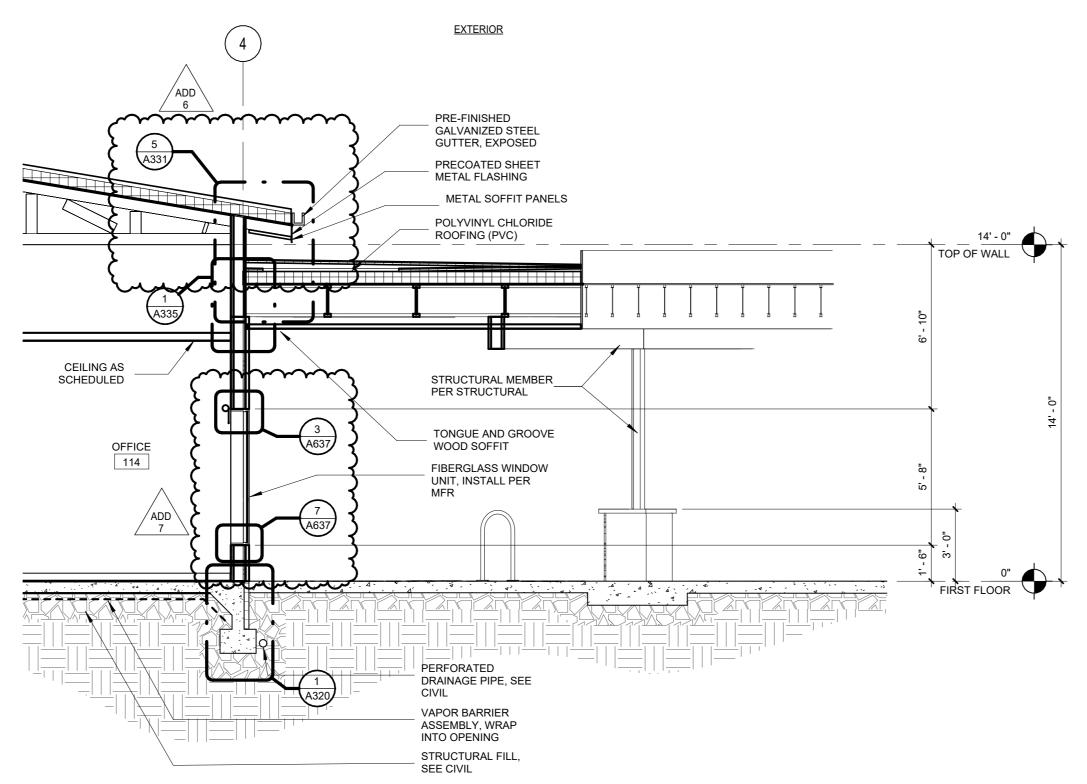


4 OFFICE @ CANOPY


1/4" = 1'-0"



ADD 4

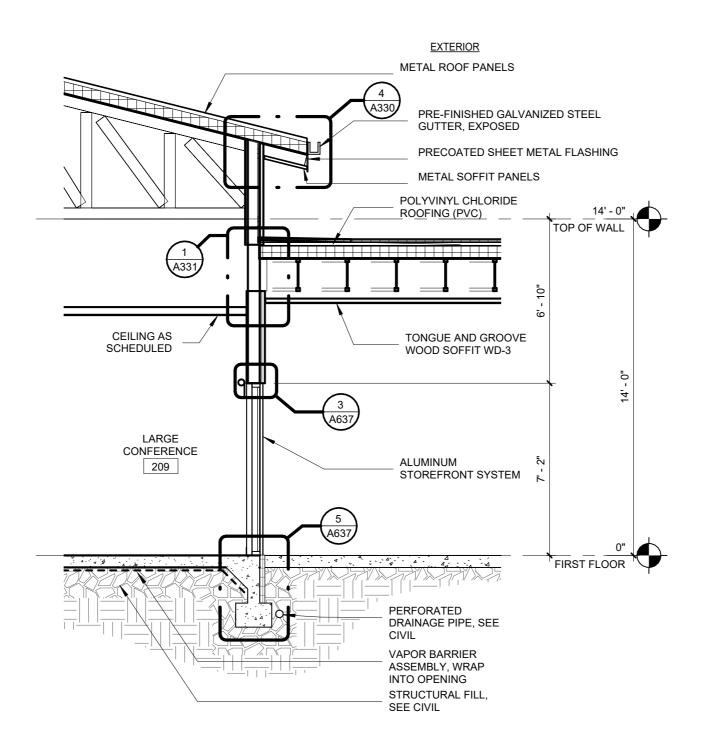


2 CONFERENCE @ CANOPY

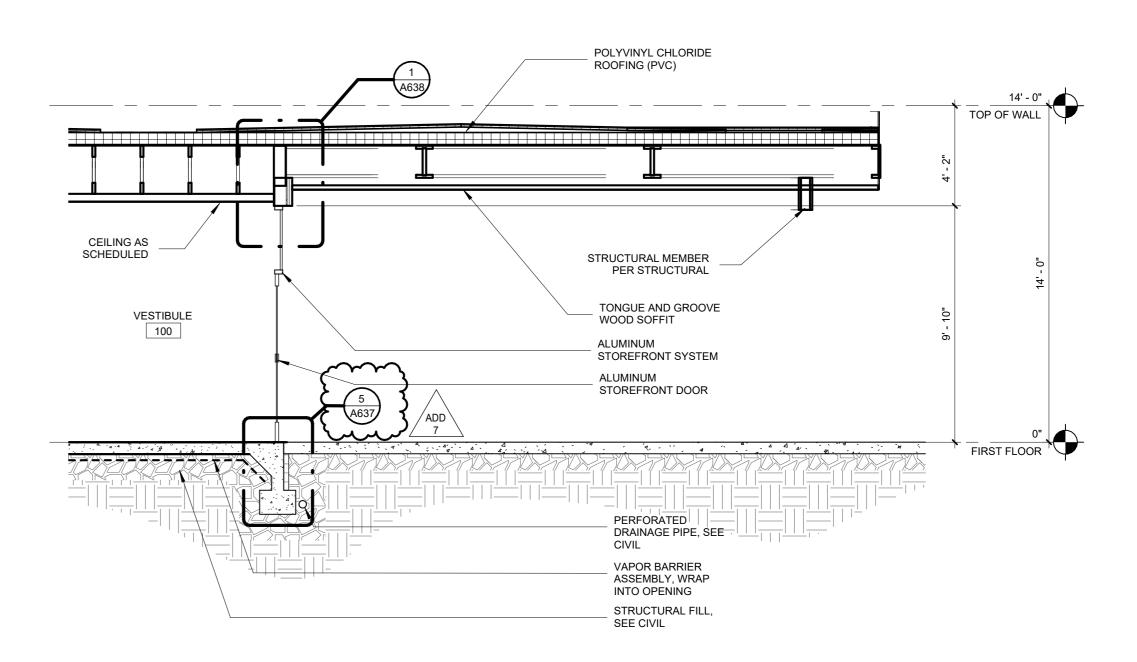

EXTERIOR

3 ENTRY VESTIBULE @ CANOPY



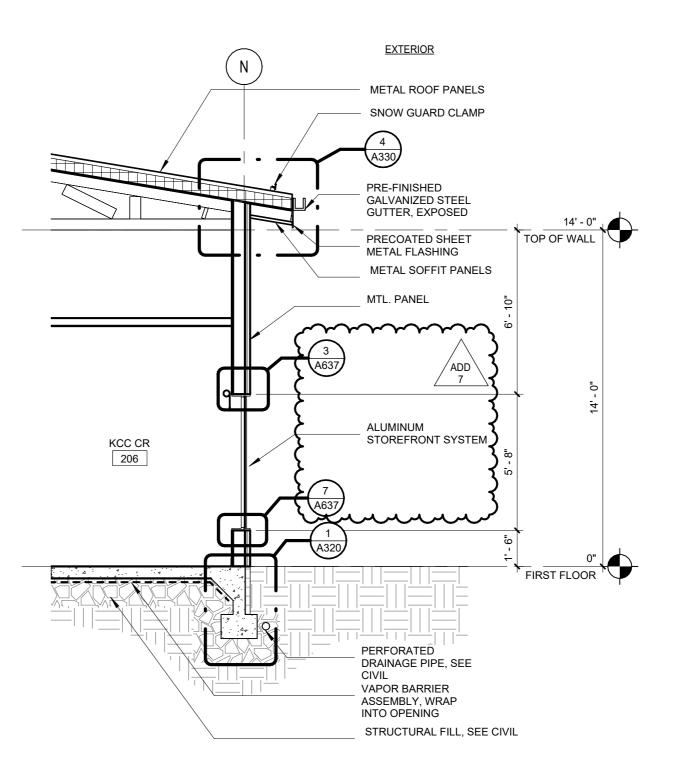

1 CLASSROOM @ SIDE WALL

1/4" = 1'-0"






S S S S

SHEET TITLE: WALL **SECTIONS**

REVISIONS: 1 ADD 4 3 ADD 6 09.12.2025 4 ADD 7 09.17.2025

ISSUE DATE: 08/01/2025

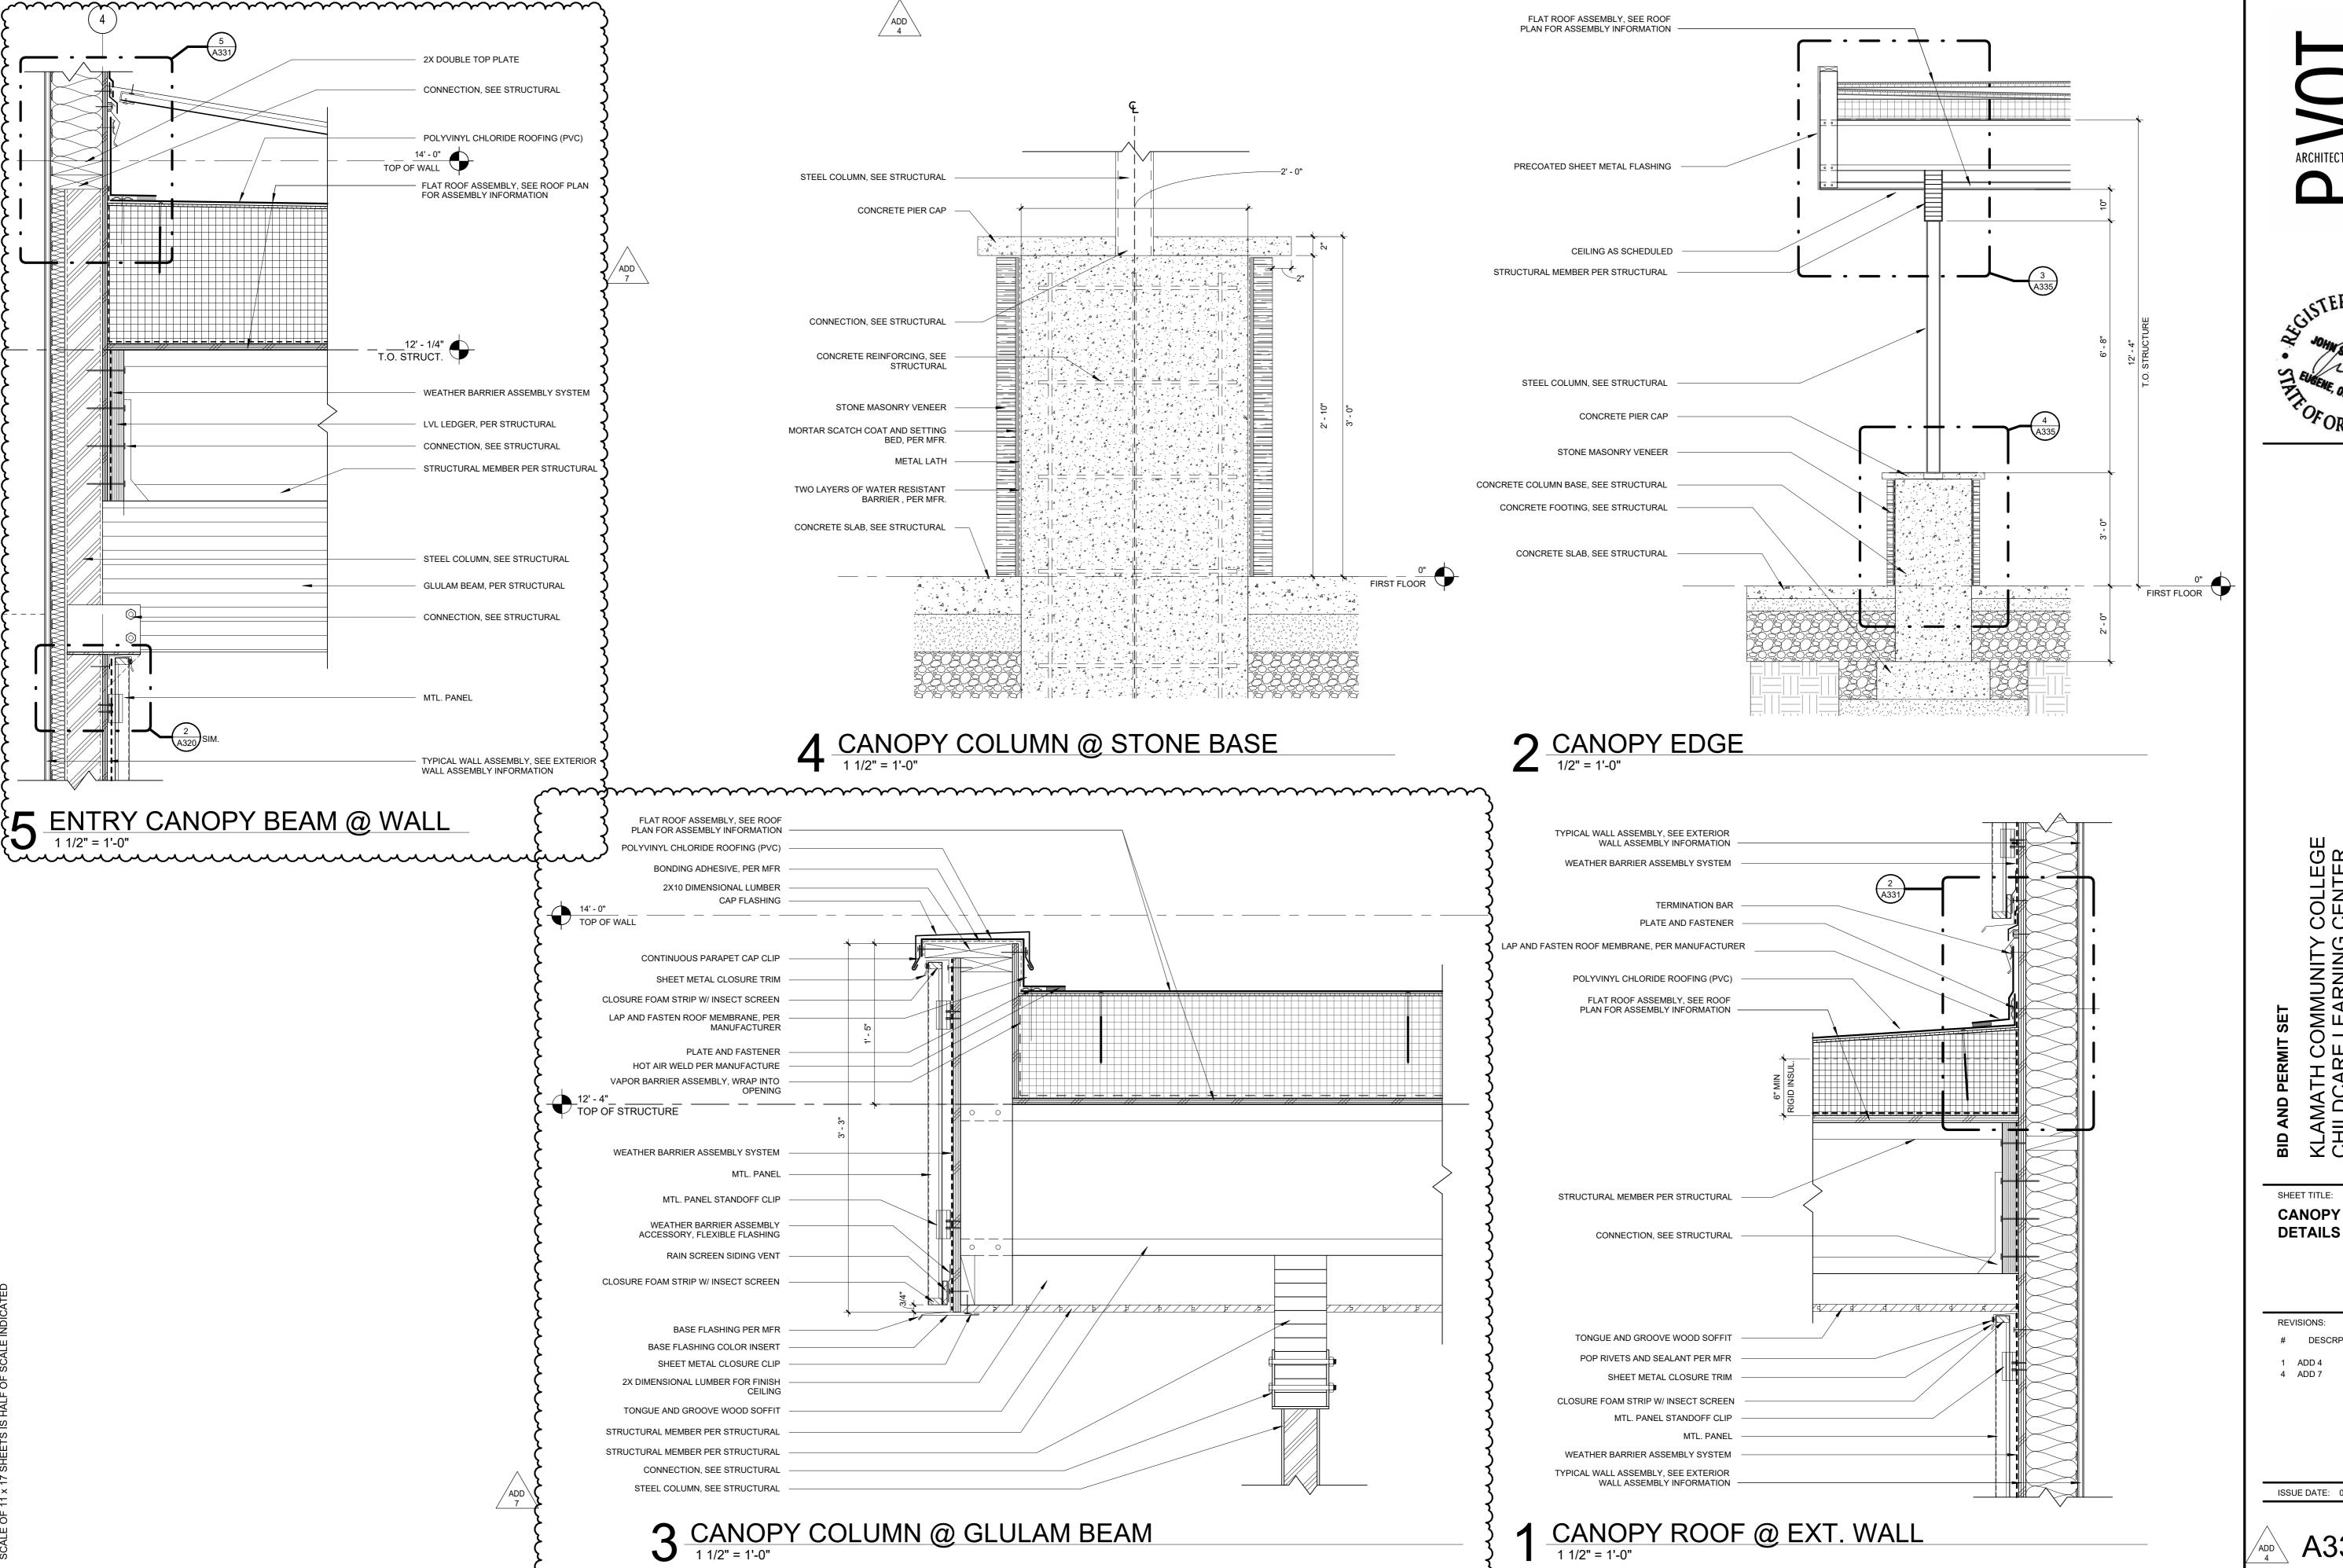



S S S

SHEET TITLE: CANOPY

VISIONS:	
DESCRP.	DATE
ADD 4 ADD 7	08.29.2025 09.17.2025

ISSUE DATE: 08/29/2025



CC CC

SHEET TITLE: TYP. OPENING **DETAILS**

REVISIONS: # DESCRP.

4 ADD 7 09.17.2025

ISSUE DATE: 08/01/2025

WALL ASSEMBLY WALL CLADDING WEATHER BARRIER ASSEMBLY ACCESSORY, FLEXIBLE FLASHING WEATHER BARRIER ASSEMBLY SYSTEM WEATHER BARRIER ASSEMBLY ACCESSORY, FLEXIBLE FLASHING WEATHER BARRIER ASSEMBLY ACCESSORY, FLEXIBLE FLASHING BENT MTL FLASHING PER INSTALLER JOINT BACKING AND SEALANT BOTH SIDES FIBERGLASS WINDOW UNIT, INSTALL PER MFR VAPOR BARRIER ASSEMBLY, WRAP INTO OPENING

6 TYP. WINDOW HEAD
3" = 1'-0"

3 TYP. STOREFRONT HEAD

WALL CLADDING

WALL ASSEMBLY

WEATHER BARRIER ASSEMBLY ACCESSORY, FLEXIBLE FLASHING

WEATHER BARRIER ASSEMBLY ACCESSORY, FLEXIBLE FLASHING

WEATHER BARRIER ASSEMBLY ACCESSORY, FLEXIBLE FLASHING

WEATHER BARRIER ASSEMBLY SYSTEM

BENT MTL FLASHING PER INSTALLER

JOINT BACKING AND SEALANT BOTH SIDES

VAPOR BARRIER ASSEMBLY, WRAP INTO OPENING

VAPOR BARRIER ASSEMBLY, WRAP INTO OPENING

JOINT BACKING AND SEALANT BOTH SIDES

JOINT BACKING AND SEALANT BOTH SIDES

BENT MTL FLASHING PER INSTALLER

WEATHER BARRIER ASSEMBLY SYSTEM

JOINT BACKING AND SEALANT BOTH SIDES

JOINT BACKING AND SEALANT BOTH SIDES

STAINLESS STEEL SILL PAN FLASHING

WEATHER BARRIER ASSEMBLY SYSTEM

SET SILL PAN IN TWO BEADS OF BEDDING SEALANT, TYP

WEATHER BARRIER ASSEMBLY ACCESSORY, FLEXIBLE FLASHING

ALUMINUM STOREFRONT SYSTEM

SHIM, TYP.

WALL CLADDING

RIGID INSUL.

CONC. SLAB

WEATHER BARRIER ASSEMBLY ACCESSORY, FLEXIBLE FLASHING

WEATHER BARRIER ASSEMBLY ACCESSORY, FLEXIBLE FLASHING

ALUMINUM STOREFRONT SYSTEM

STAINLESS STEEL FLASHING

WALL CLADDING

2 TYP. STOREFRONT JAMB


3" = 1'-0"

STAINLESS STEEL FLASHING

ALUMINUM STOREFRONT SYSTEM

WALL ASSEMBLY

WALL CLADDING VAPOR BARRIER ASSEMBLY, WRAP INTO OPENING WEATHER BARRIER ASSEMBLY ACCESSORY, FLEXIBLE FLASHING FIBERGLASS WINDOW UNIT, INSTALL PER MFR JOINT BACKING AND SEALANT BOTH SIDES WEATHER BARRIER ASSEMBLY ACCESSORY, FLEXIBLE FLASHING WEATHER BARRIER ASSEMBLY ACCESSORY, FLEXIBLE FLASHING BENT MTL FLASHING PER INSTALLER WEATHER BARRIER ASSEMBLY SYSTEM WALL CLADDING

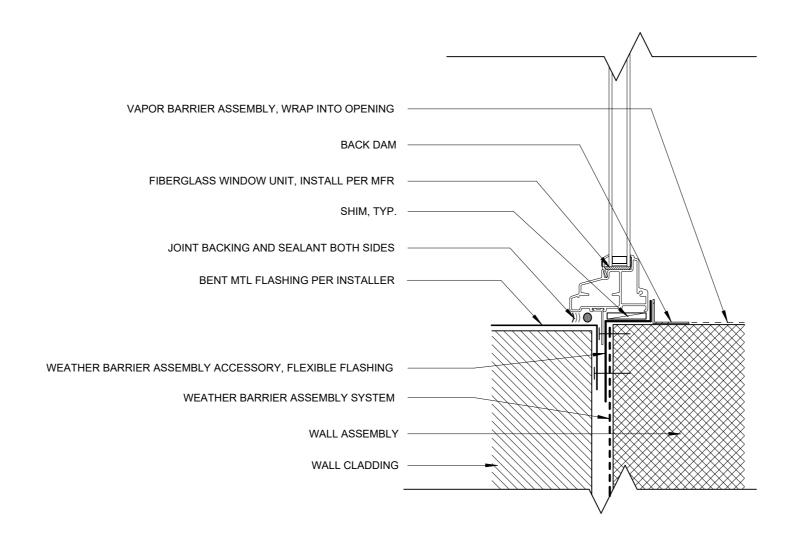

7 TYP. DOOR SILL 3" = 1'-0"

4 TYP. WINDOW SILL

3" = 1'-0"

VAPOR BARRIER ASSEMBLY, WRAP INTO OPENING WALL ASSEMBLY INTERIOR CORNER JOINT SEALANT HOLLOW METAL FRAME WEATHER BARRIER ASSEMBLY ACCESSORY, FLEXIBLE FLASHING HOLLOW METAL DOOR HOLLOW METAL DOOR FLANGE JOINT BACKING AND SEALANT WEATHER BARRIER ASSEMBLY ACCESSORY, FLEXIBLE FLASHING WEATHER BARRIER ASSEMBLY ACCESSORY, FLEXIBLE FLASHING BENT MTL FLASHING PER INSTALLER WALL CLADDING

8 TYP. DOOR JAMB
3" = 1'-0"

HOLLOW METAL DOOR

DOOR BOTTOM SWEEP

CONTINUOUS BED OF SEALANT

STAINLESS STEEL FLASHING

WEATHER BARRIER ASSEMBLY SYSTEM

WEATHER BARRIER ASSEMBLY ACCESSORY, FLEXIBLE FLASHING

SADDLE THRESHOLD

WALL CLADDING

CONC. SLAB

WALL ASSEMBLY

WALL CLADDING

JOINT SEALANT

WEATHER BARRIER ASSEMBLY ACCESSORY, FLEXIBLE FLASHING

WEATHER BARRIER ASSEMBLY ACCESSORY, FLEXIBLE FLASHING

WEATHER BARRIER ASSEMBLY ACCESSORY, FLEXIBLE FLASHING

WEATHER BARRIER ASSEMBLY SYSTEM

BENT MTL FLASHING PER INSTALLER

VAPOR BARRIER ASSEMBLY, WRAP INTO OPENING

JOINT BACKING AND SEALANT

HOLLOW METAL DOOR FLANGE

INTERIOR CORNER JOINT SEALANT

HOLLOW METAL FRAME

HOLLOW METAL DOOR

9 TYP. DOOR HEAD
3" = 1'-0"

1 TYP. STOREFRONT SILL
3" = 1'-0"

5 TYP. WINDOW JAMB



3 DOOR HEAD @ METAL PANEL

VAPOR BARRIER ASSEMBLY, WRAP INTO OPENING

TYPICAL WALL ASSEMBLY, SEE EXTERIOR

WEATHER BARRIER ASSEMBLY SYSTEM

(2) HSW FASTENERS PER CLIP, PER MFR

CLOSURE FOAM STRIP W/ INSECT SCREEN

WEATHER BARRIER ASSEMBLY ACCESSORY, FLEXIBLE FLASHING

WEATHER BARRIER ASSEMBLY ACCESSORY, FLEXIBLE FLASHING

WALL ASSEMBLY INFORMATION

MTL. PANEL STANDOFF CLIP


RAIN SCREEN SIDING VENT


BASE FLASHING PER MFR JOINT BACKING AND SEALANT HOLLOW METAL DOOR FLANGE

HOLLOW METAL FRAME

INTERIOR CORNER JOINT SEALANT

MTL. PANEL

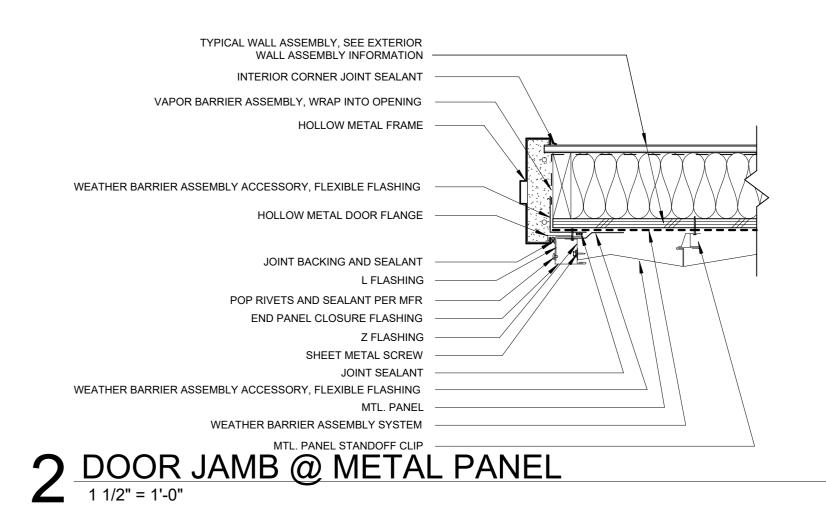

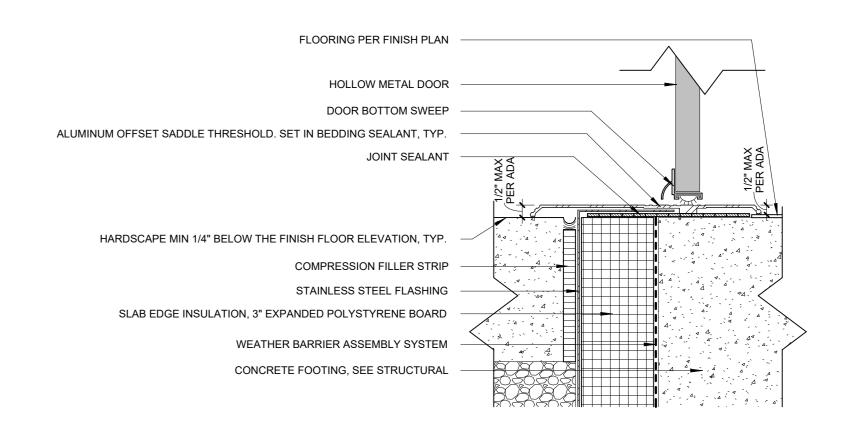

1 DOOR SILL @ CONC. FLOOR
3" = 1'-0"

REVISIONS: # DESCRP. 4 ADD 7 09.17.2025

DOOR DETAILS


KLAMATH COMMUNITY CC CHILDCARE LEARNING CE

SHEET TITLE:


ISSUE DATE: 08/01/2025





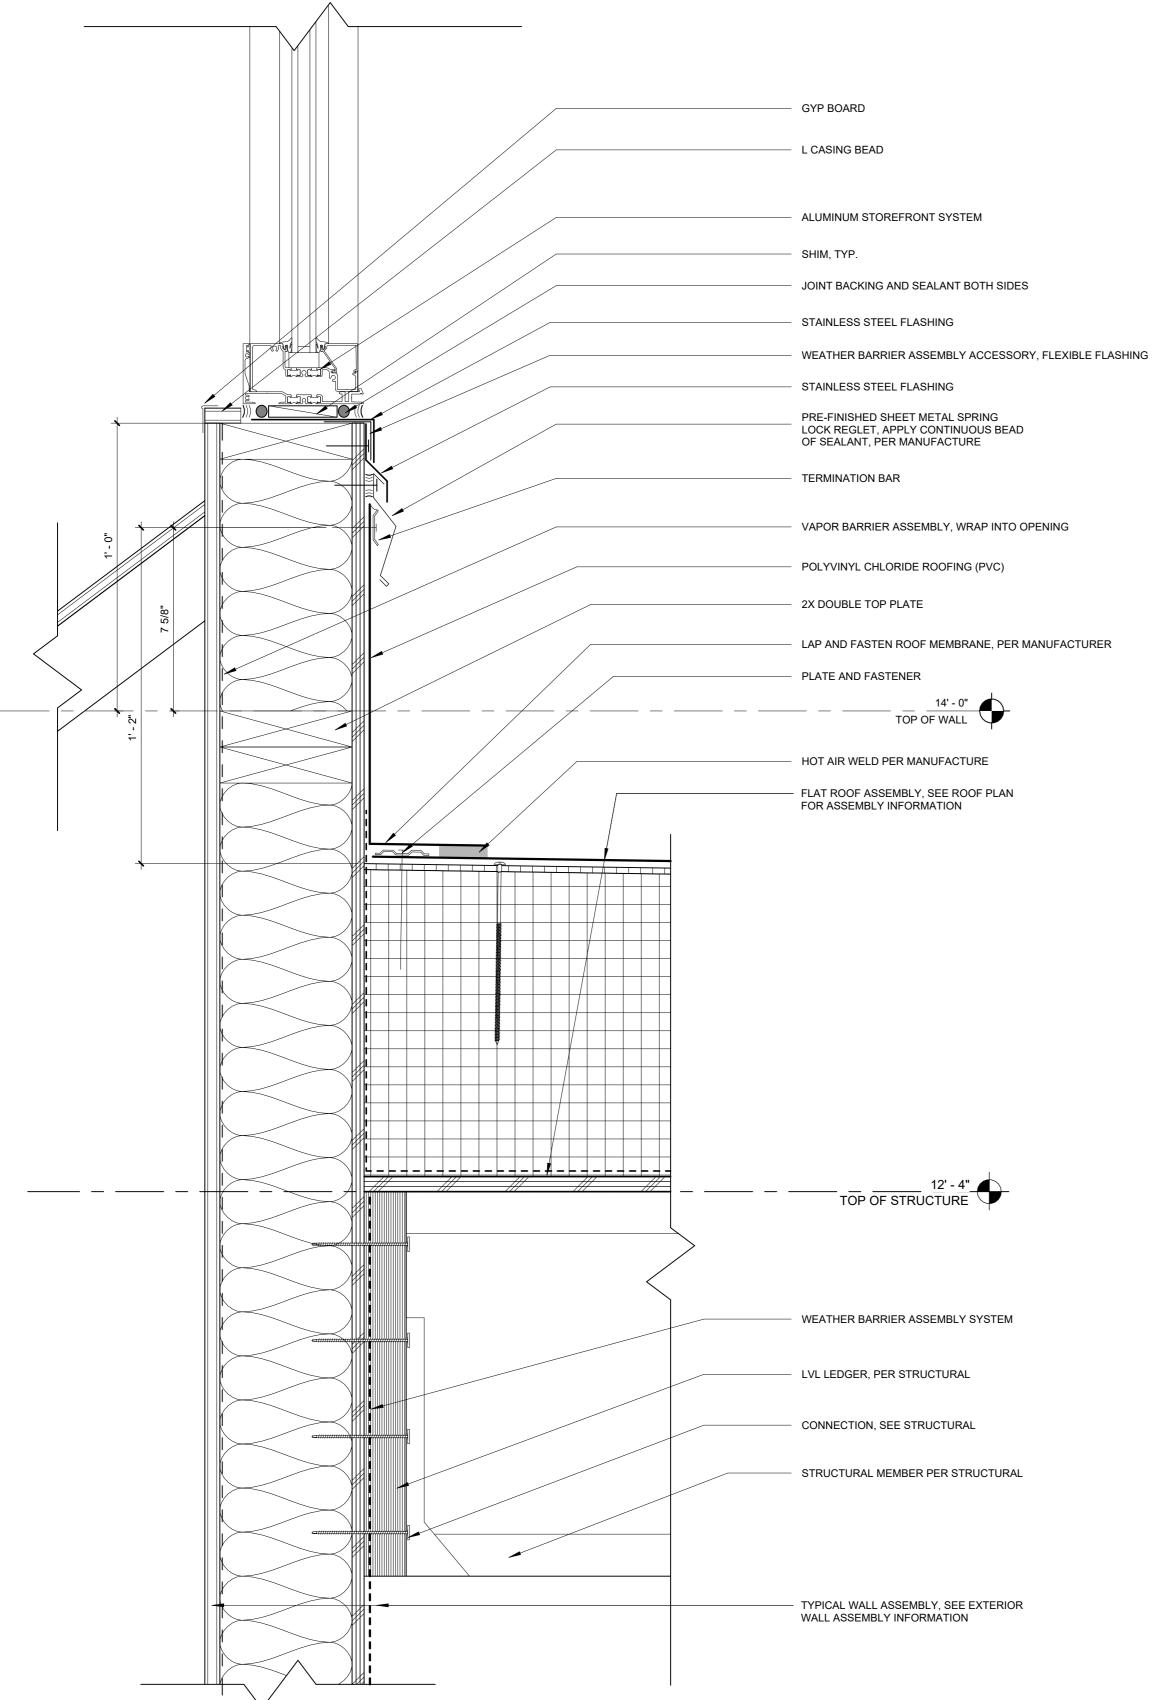

2 STOREFRONT SILL @ PVC ROOF

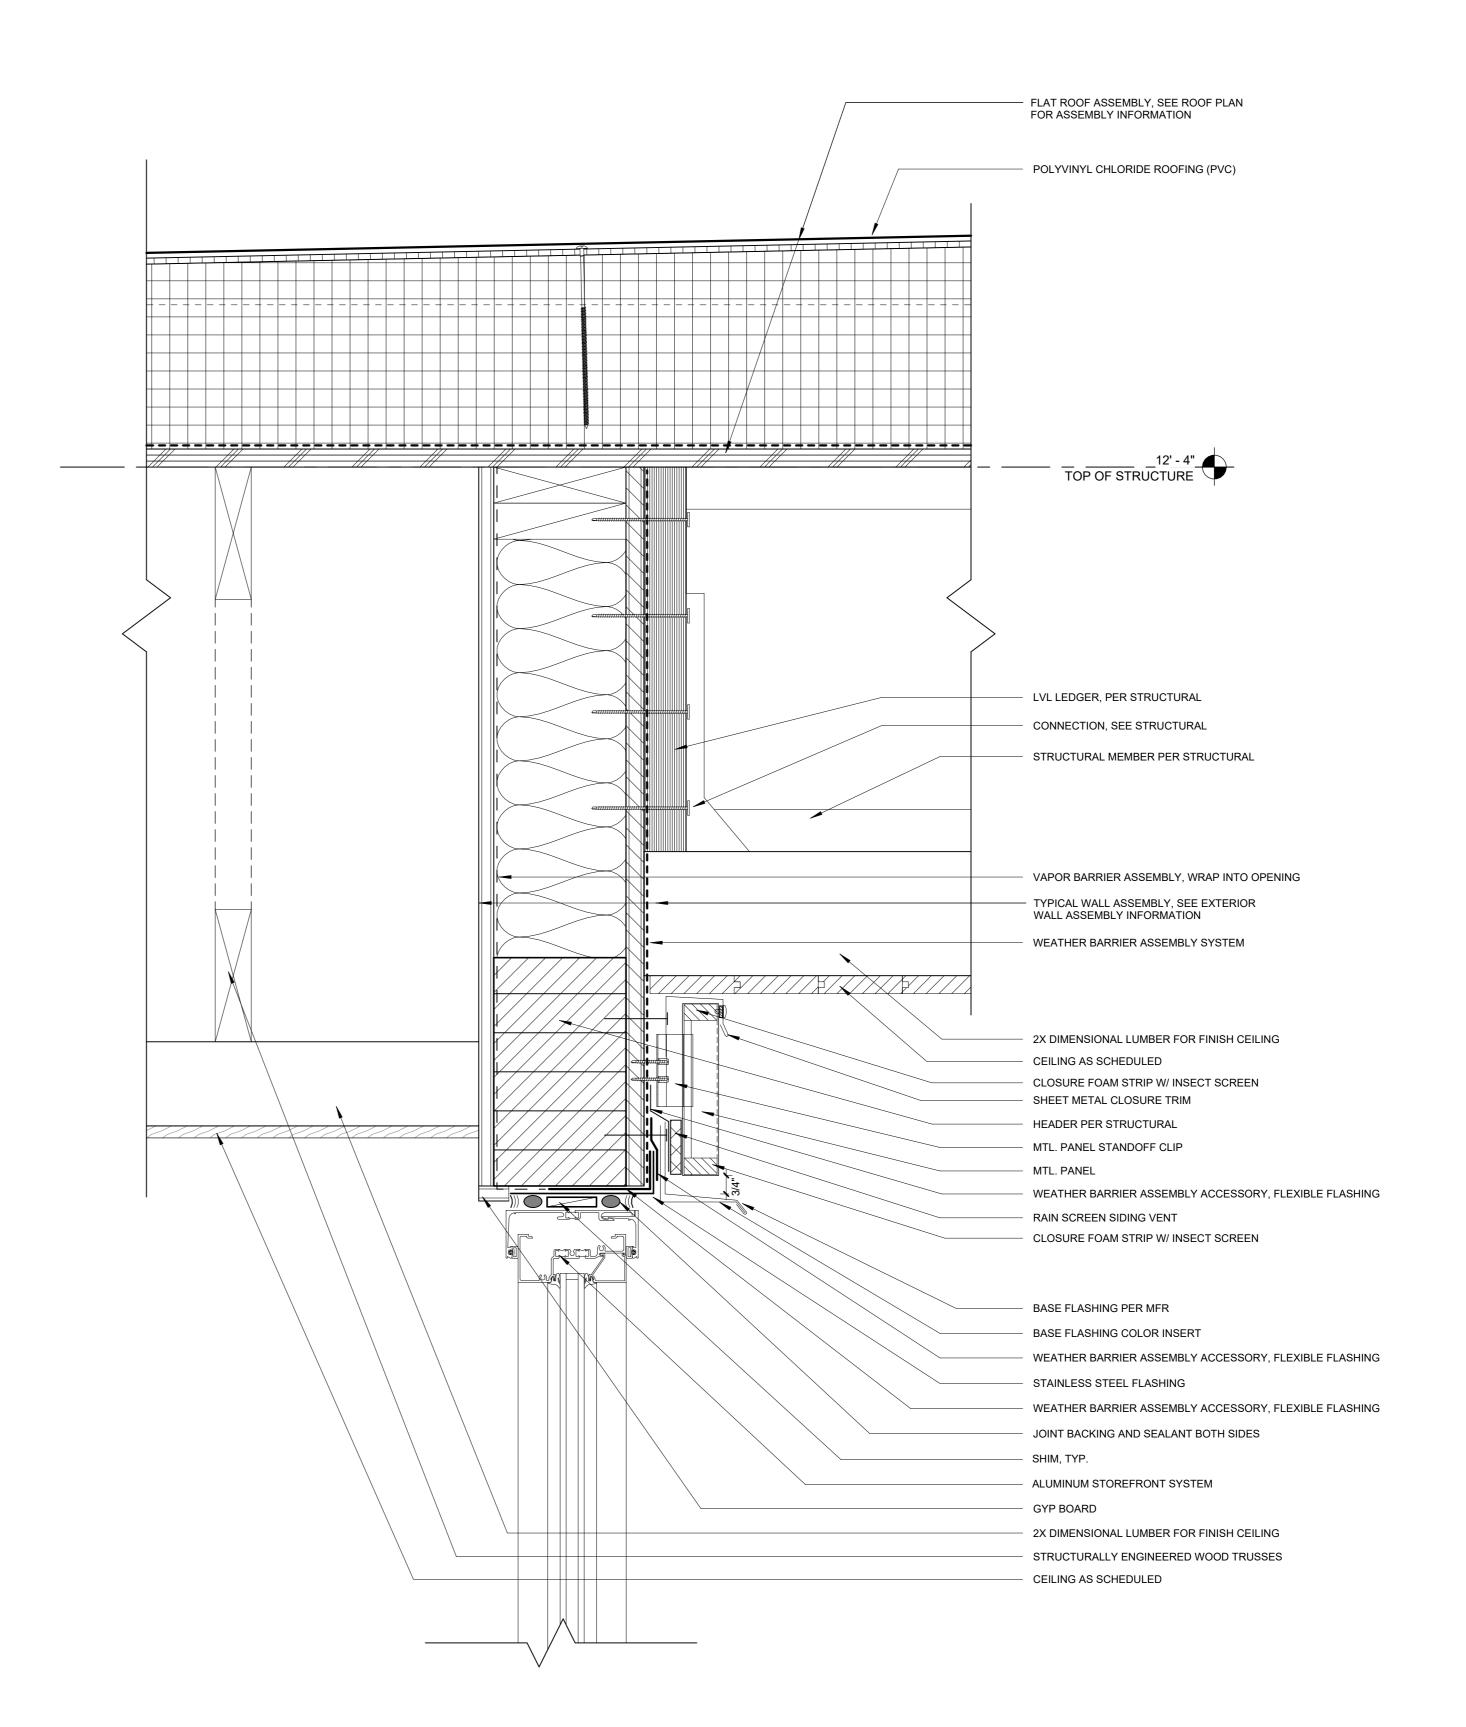

1 ENTRY VESTIBULE STOREFRONT @ CANOPY ROOF 3" = 1'-0"





CC CC

DETAILS

STOREFRONT

SHEET TITLE:


REVISIONS: 4 ADD 7

ISSUE DATE: 08/01/2025




L CASING BEAD GYP BOARD FIBERGLASS WINDOW UNIT, INSTALL PER MFR INTERIOR CORNER JOINT SEALANT TYPICAL WALL ASSEMBLY, SEE INTERIOR WALL ASSEMBLY INFORMATION

3 INT. WINDOW JAMB 1 1/2" = 1'-0"

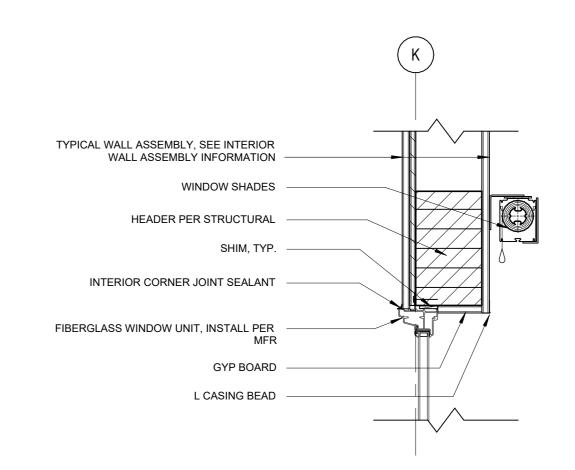

2 INT. WINDOW HEAD 1 1/2" = 1'-0"

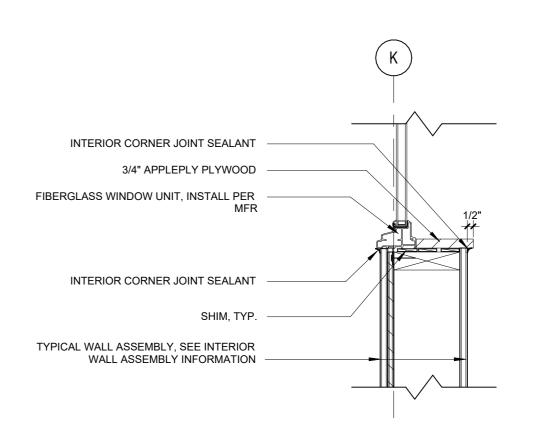

1 INT. WINDOW SILL
1 1/2" = 1'-0"





KLAMATH COMMUNITY CC CHILDCARE LEARNING CE


SHEET TITLE: INT. WINDOW **DETAILS**

RE'	VISIONS:	
#	DESCRP.	DATE
4	ADD 7	09.17.202

ISSUE DATE: 08/01/2025



2 HOLLOW METAL DOOR HEAD 3" = 1'-0"

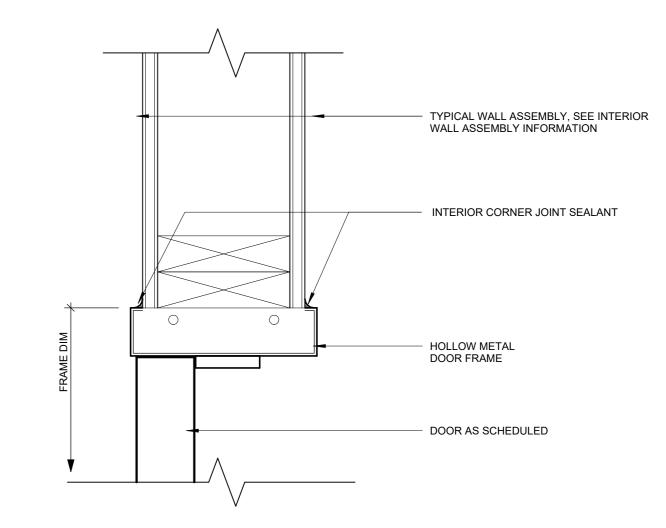

1 HOLLOW METAL DOOR JAMB
3" = 1'-0"

REVISIONS:
DESCRP. DA

SHEET TITLE:

INT. DOOR DETAILS

KLAMATH COMMUNITY COLLEGE CHILDCARE LEARNING CENTER

DESCRP. DATE
4 ADD 7 09.17.2025

ISSUE DATE: 08/01/2025

A653

ROOF AND FLOOR FRAMING PLAN NOTES

	COORDINATE ALL DIMENSIONS & FEATURES NOT SHOWN WITH ARCHITECT.	J.		INDICATES SHEAR WALL LOCATION BELOW FRAMING. SEE SHEAR WALL SCHEDULE ON SHEET S007 FOR ADDITIONAL INFORMATION.	
	SEE SHEET S001 AND S002 FOR ALL NOTES.				
	SEE SHEET S007 FOR ALL SCHEDULES.	K.		INDICATES 2x6 @ 16" o.c. BEARING STUDWALL BELOW FRAMING w/ DOUBLE TOP PLATE AND SINGLE P.T. BOTTOM PLATE, U.N.O.	
	ALL KEYNOTES INDICATE NEW ITEMS TYPICALLY UNLESS NOTED OTHERWISE.	ı		ALL SHEAR WALLS INDICATED AS "PERFORATED"	
		L.		THE CONTRACTOR SHALL PROVIDE NAILING	_
	TRUSS LAYOUT IS FOR REFERENCE ONLY. CONFIRM LAYOUT & BEARING CONDITIONS WITH TRUSS SUPPLIER'S LAYOUT PLAN.			PATTERN AROUND ALL WALL PENETRATIONS AS CALLED OUT ON FRAMING PLANS IN CORRESPONDENCE WITH THE SHEAR WALL SCHEDULE.	
	INDICATES ROOF STEP, TYP.				
	SEE ARCHITECTURAL PLANS FOR ADDITIONAL INFORMATION.	M.	F.T.A.O.	INDICATES FORCE TRANSFER AROUND OPENING IN WALL. PROVIDE PANEL EDGE NAILING AROUND ALL WALL PENETRATIONS PER SHEAR WALL SCHEDULE.	
	BEAMS ARE EQUALLY SPACED IN BAYS, U.N.O.			SEE ASSOCIATED ELEVATION FOR ADDITIONAL INFORMATION.	
	BEAMS ARE CENTERED ON COLUMNS, WALLS,	N.I		INDICATES HOLDOWN TYPE AND LOCATION SEE	
\wedge	AND/OR GRID LINES, U.N.O.	N.	(#)	INDICATES HOLDOWN TYPE AND LOCATION. SEE HOLDOWN SCHEDULE FOR ADDITIONAL	
⟨ x ⟩	INDICATES SHEAR WALL TYPE. SEE SHEAR WALL SCHEDULE ON SHEET S007 FOR ADDITIONAL		•	INFORMATION.	
	INFORMATION.	Ο.	HDR-X	INDICATES HEADER SIZE. SEE HEADER SCHEDULE	

(D)

MEZZANINE FLOOR # FRAMING KEYNOTES

	(
\wedge	1. (1 1/8" PLYWOOD FLOOR SHEATHING w/ 3"x0.148"Ø NAILS
/ \	}	@ 6" o.c. BOUNDARY & PANEL EDGE AND 12" o.c. FIELD
.DD\ -		NAILING. BLOCK AND ALL PANEL EDGES w/ FLAT 2x BLOCKING
7	7	
	2.	MECHANICAL UNIT BY OTHERS. MAX. WEIGHT = 3,000 LBS.
	کے	
\wedge	3.	5 1/2x9 1/4 GLB. POCKET INTO STUD WALL AND PROVIDE (2)
.DD\		STUDS AND KING STUD EACH FACE.
7	7	
	4.	4x FULL DEPTH DRAG BLOCKING IN WALL CAVITY FOR FULL
		LENGTH OF SHEAR WALL w/ SIMPSON CMST12 COIL STRAP w/
		3"x0.148"Ø NAILS.
	5.	2x6 CEILING JOISTS @ 16" o.c. w/ SIMPSON LUS26 FACE
		MOUNT HANGER.

2x6 LEDGER. ATTACH TO EACH STUD w/ (2) SIMPSON SDWS22400DB SCREWS. 5 1/2x7 1/2 GLB POCKET IN STUD WALL AND PROVIDE (2) STUDS AND KING STUD EACH SIDE.

APPROXIMATE LOCATION OF 60"x28" PLATFORM ACCESS
PANEL. PROVIDE DOUBLE TRIMMER JOIST EACH SIDE AND DOUBLE JOIST HEADER BOTH w/ SIMPSON LUS26-2 FACE

42"x36" PLATFORM w/ 5/8" PLYWOOD SHEATHING w/

2 1/2"x0.148"Ø NAILS @ 6" o.c. PANEL EDGE AND 12" o.c. FIELD

10. 2x6 STUDS @ 16" o.c. w/ DOUBLE TOP PLATE AND SINGLE BOTTOM PLATE ON TOP OF BEAM AT PLATFORM.

C PARTIAL HEIGHT



SHEET TITLE: **HALLWAY WALL** FRAMING PLAN -


SECTOR A


REVISIONS:				
#	DESCRP.	DATE		
1	ADD 4	08.29.2025		

ADD 5 09.05.2025 ADD 7

ISSUE DATE: 08/01/2025


S213

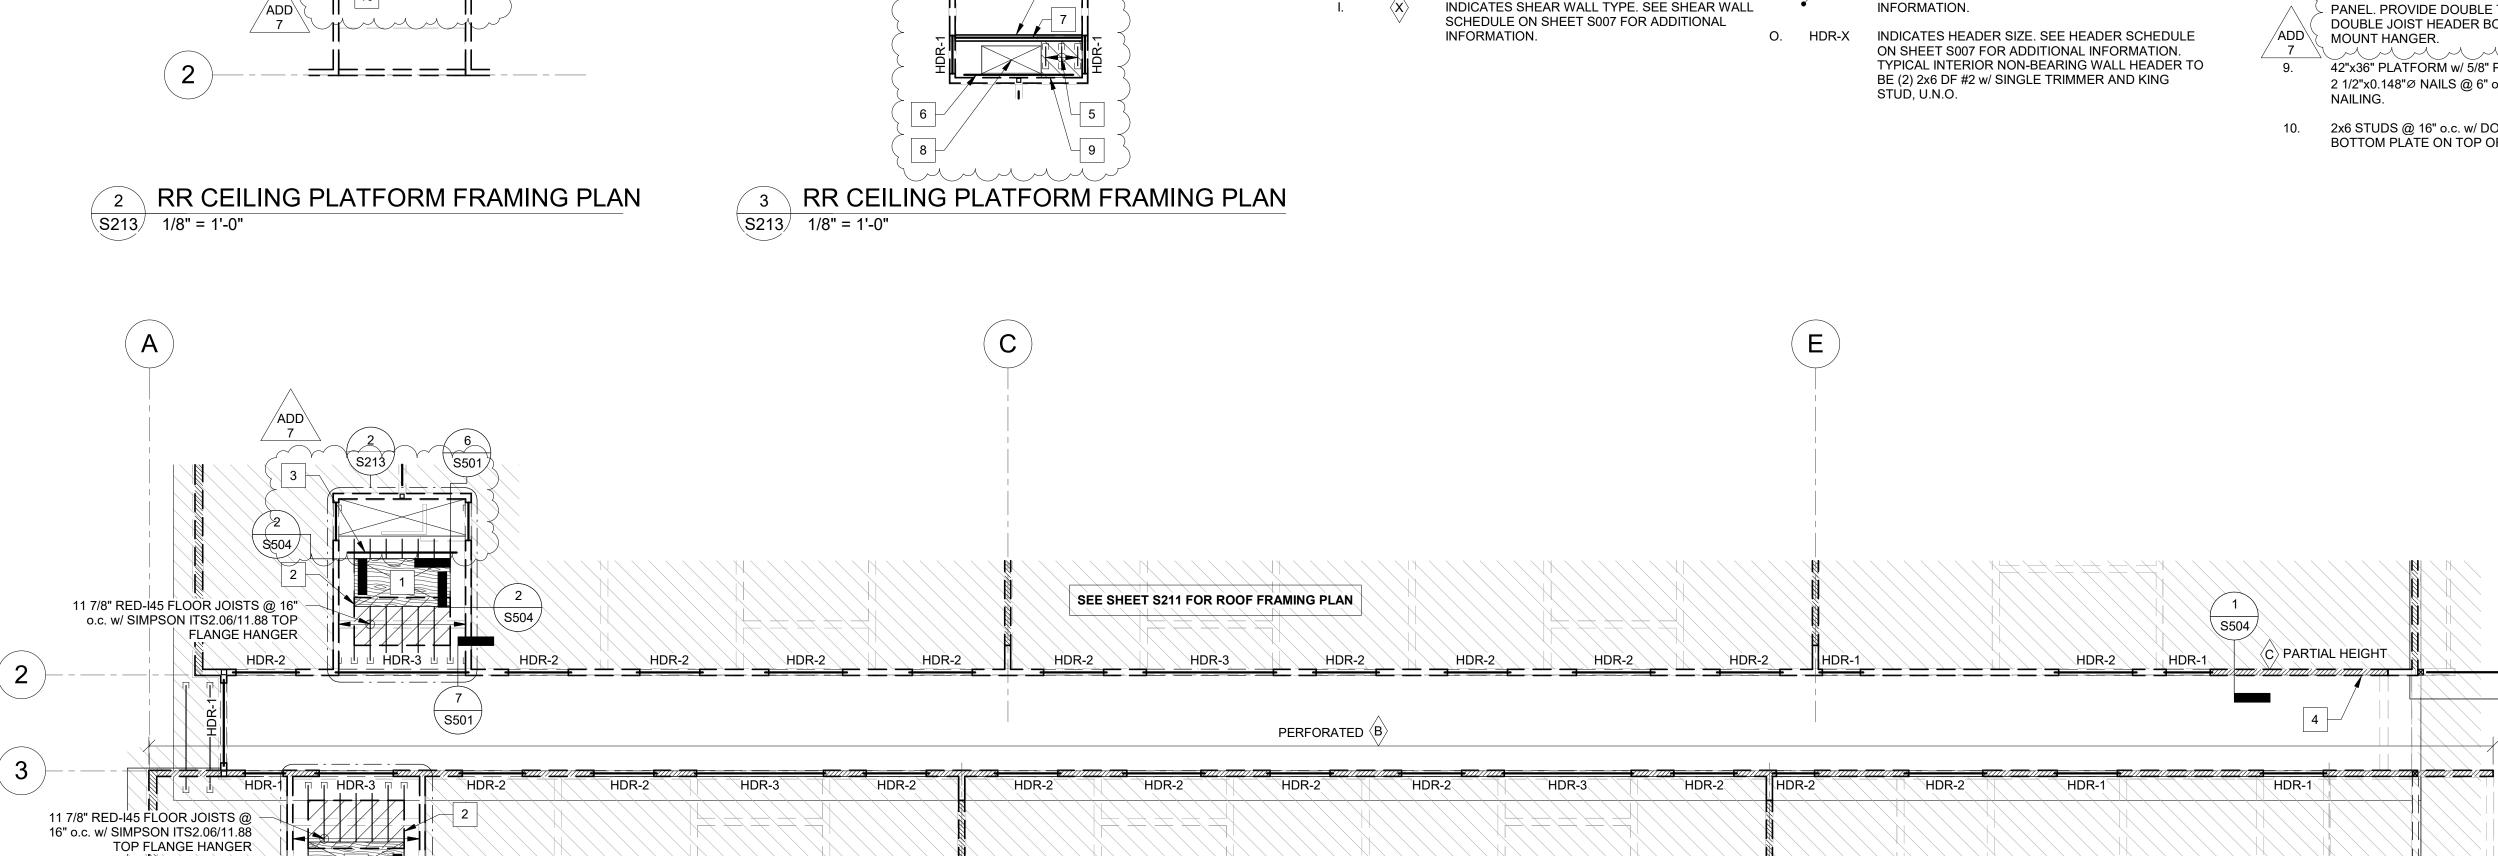

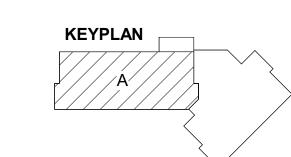


\$504



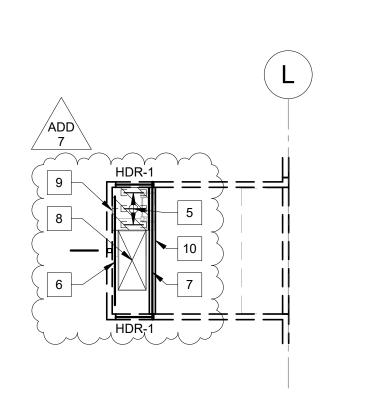

2 RR CEILING PLATFORM FRAMING PLAN S214 1/8" = 1'-0"

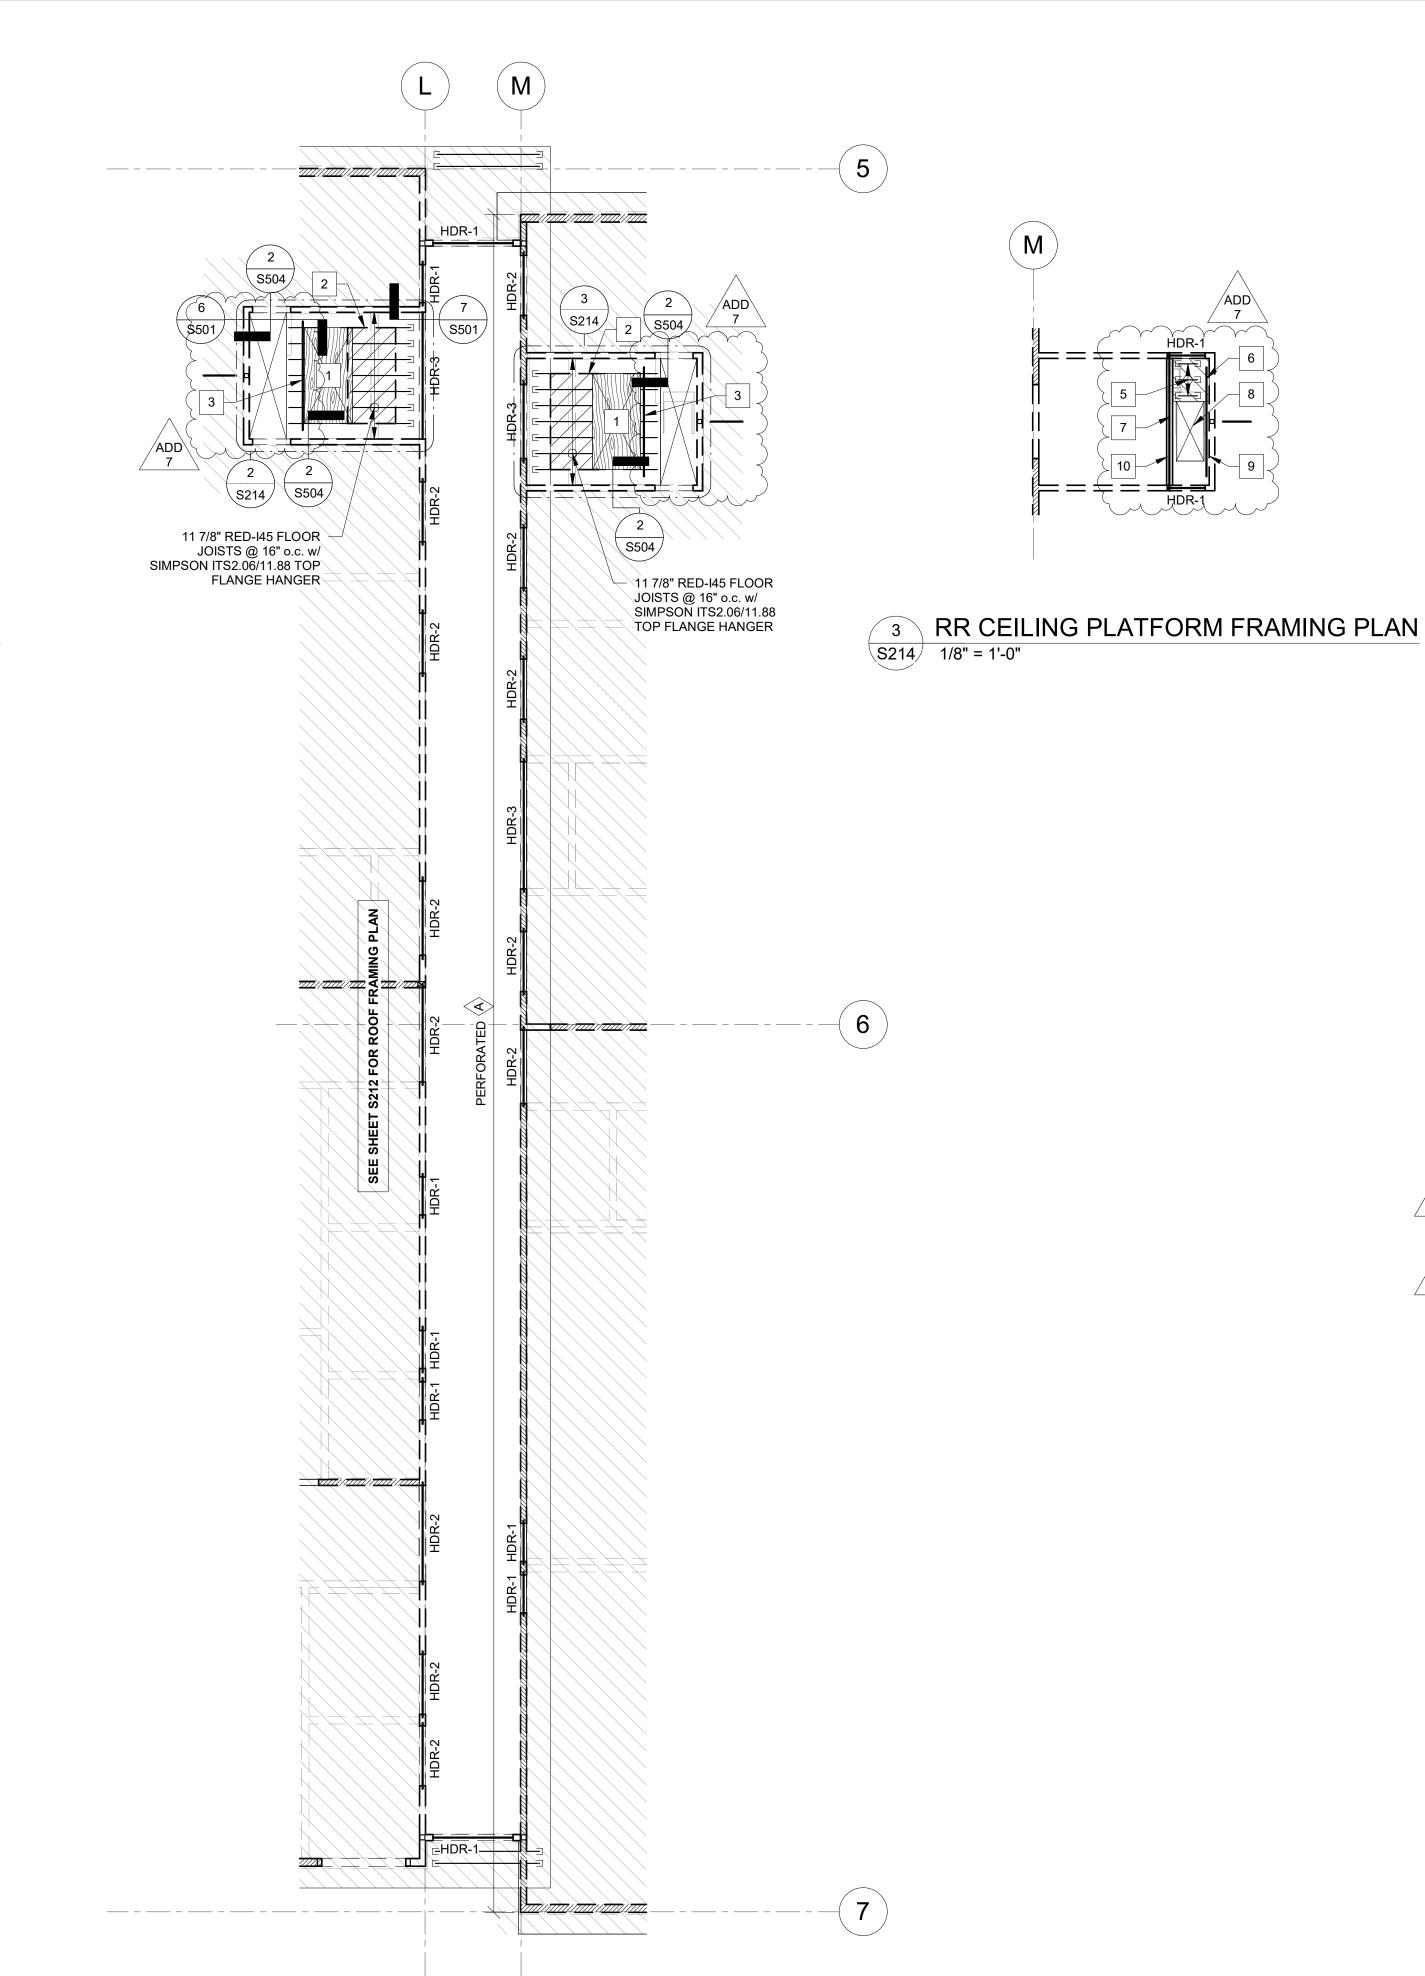

S214 1/8" = 1'-0"

HALLWAY WALL FRAMING PLAN - SECTOR B

ROOF AND FLOOR FRAMING PLAN NOTES

SEE SHEET S001 AND S002 FOR ALL NOTES. SEE SHEET S007 FOR ALL SCHEDULES. ALL KEYNOTES INDICATE NEW ITEMS TYPICALLY UNLESS NOTED OTHERWISE. TRUSS LAYOUT IS FOR REFERENCE ONLY. CONFIRM LAYOUT & BEARING CONDITIONS WITH TRUSS SUPPLIER'S LAYOUT PLAN.

SHOWN WITH ARCHITECT.

INDICATES ROOF STEP TYP. SEE ARCHITECTURAL PLANS FOR ADDITIONAL INFORMATION.

COORDINATE ALL DIMENSIONS & FEATURES NOT

BEAMS ARE EQUALLY SPACED IN BAYS, U.N.O. BEAMS ARE CENTERED ON COLUMNS, WALLS,

INDICATES SHEAR WALL TYPE. SEE SHEAR WALL SCHEDULE FOR ADDITIONAL INFORMATION.

AND/OR GRID LINES, U.N.O.

BOTTOM PLATE, U.N.O.

INDICATES SHEAR WALL LOCATION BELOW FRAMING.
SEE SHEAR WALL SCHEDULE ON SHEET S007 FOR ADDITIONAL INFORMATION. INDICATES 2x6 @ 16" o.c. BEARING STUD WALL BELOW

FRAMING W/ DOUBLE TOP PLATE AND SINGLE P.T.

> ALL SHEAR WALLS INDICATED AS "PERFORATED" THE CONTRACTOR SHALL PROVIDE NAILING PATTERN AROUND ALL WALL PENETRATIONS AS CALLED OUT ON FRAMING PLANS IN CORRESPONDENCE WITH THE SHEAR WALL SCHEDULE.

M. F.T.A.O. INDICATES FORCE TRANSFER AROUND OPENING IN WALL. PROVIDE PANEL EDGE NAILING AROUND ALL WALL PENETRATIONS PER SHEAR WALL SCHEDULE. SEE ASSOCIATED ELEVATION FOR ADDITIONAL INFORMATION.

INDICATES HOLDOWN TYPE AND LOCATION. SEE HOLDOWN SCHEDULE FOR ADDITIONAL INFORMATION.

O. HDR-X INDICATES HEADER SIZE. SEE HEADER SCHEDULE ON SHEET S007 FOR ADDITIONAL INFORMATION. TYPICAL INTERIOR NON-BEARING WALL HEADER TO BE (2) 2x6 DF #2 w/ SINGLE TRIMMER AND KING STUD, U.N.O.

MEZZANINE FLOOR **# FRAMING KEYNOTES**

1 1/8" PLYWOOD FLOOR SHEATHING w/ 3"x0.148"Ø NAILS - @ 6" o.c. BOUNDARY & PANEL EDGE AND 12" o.c. FIELD NAILING. BLOCK AND ALL PANEL EDGES w/ FLAT 2x BLOCKING. MECHANICAL UNIT BY OTHERS. MAX. WEIGHT = 3,000 LBS.

5 1/2x9 1/4 GLB. POCKET INTO STUD WALL AND PROVIDE (2) STUDS AND KING STUD EACH FACE.

4x FULL DEPTH DRAG BLOCKING IN WALL CAVITY FOR FULL LENGTH OF SHEAR WALL w/ SIMPSON CMST12 COIL STRAP w/ 3"x0.148"Ø NAILS.

2x6 CEILING JOISTS @ 16" o.c. w/ SIMPSON LUS26 FACE MOUNT HANGER.


2x6 LEDGER. ATTACH TO EACH STUD w/ (2) SIMPSON SDWS22400DB SCREWS.

5 1/2x7 1/2 GLB POCKET IN STUD WALL AND PROVIDE (2) STUDS AND KING STUD EACH SIDE. APPROXIMATE LOCATION OF 60"x28" PLATFORM ACCESS

 $\,\,\,$ PANEL. PROVIDE DOUBLE TRIMMER JOIST EACH SIDE AND $\,\,$ DOUBLE JOIST HEADER BOTH w/ SIMPSON LUS26-2 FACE ADD\\ MOUNT HANGER. 42"x36" PLATFORM w/ 5/8" PLYWOOD SHEATHING w/ 2 1/2"x0.148"Ø NAILS @ 6" o.c. PANEL EDGE AND 12" o.c. FIELD

10. 2x6 STUDS @ 16" o.c. w/ DOUBLE TOP PLATE AND SINGLE BOTTOM PLATE ON TOP OF BEAM AT PLATFORM.

NAILING.

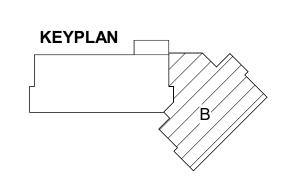

ARCHITECTURE





SHEET TITLE: **HALLWAY WALL** FRAMING PLAN -

SECTOR B

REVISIONS: # DESCRP. DATE 08.29.2025

ADD 5

ADD 7

09.05.2025

09.17.2025

ISSUE DATE: 08/01/2025

S214

ARCHITECTURE



ZCS

BID & PERMIT SET

KLAMATH COMMUNITY COLLEG

EARLY LEARNING CENTER

PROJECT #: K-6381-24

SHEET TITLE:

ROOF FRAMIN

ROOF FRAMING DETAILS

REVISIONS:

DESCRP. DATE

1 ADD 4 08.29.2025
2 ADD 5 09.05.2025
4 ADD 7 09.17.2025

ISSUE DATE: 08/01/2025

S501